


Luminaire Schedule										
Symbol	Qty	Label	Arrangement	Lum.	Illum.	LSP	Description	Loc. Watts	Total Watts	
LS-1	1		SINGLE	88402	0.919	498-08-04405-57-70-10-000		681	4116	
LS-2	1		SINGLE	89440	0.919	498-08-04405-57-70-10-000		681	4116	
LS-3	1	LS-3	SINGLE	89540	0.919	498-08-04405-57-70-10-000		681	38136	
LS-4	1	LS-4	SINGLE	89596	0.919	498-08-04405-57-70-10-000		681	2724	
LS-5	10	LS-5	SINGLE	90304	0.919	498-08-04405-57-70-10-000		681	12258	

Calculation Summary									
Label	Category	UnitType	Units*	Avg	Max	Min	Avg/Min	Max/Min	Unit #
Field 1 & 2 * AFF	Illuminate	fc		21.15	45.1	10.7	1.91	5	
Field 2 & 3 * AFF	Illuminate	fc		38.22	75.0	18.9	1.92	3.70	3
Field 3 & 3 * AFF	Illuminate	fc		38.43	64.1	18.6	1.98	3.46	3
Split Light # Grade	Illuminate	fc		1.07	9.5	0.2	5.35	47.50	0
INFIELD 1	Illuminate	fc		54.19	65.3	34.1	1.59	1.91	
INFIELD 2	Illuminate	fc		54.71	70.0	37.9	1.44	1.85	
INFIELD 3	Illuminate	fc		54.81	70.0	37.9	1.44	1.85	
OUTFIELD 1	Illuminate	fc		55.49	44.2	18.2	1.79	2.30	
OUTFIELD 2	Illuminate	fc		56.97	43.9	18.9	1.44	2.22	
OUTFIELD 3	Illuminate	fc		57.29	45.4	18.6	1.74	2.45	

SOFTBALL BIS RP-6-15
*DEFENDED FIELD AREA IS EXTENDED TO INCLUDE THE SPACE FROM THE BASELINE TO THE FENCE
A POLES - BASELINE(60) x STRUCK2
B POLES - DISTANCE STRAIGHT TO DIAGONAL/C
C POLES - DISTANCE STRAIGHT TO OUTFIELD FENCE
*THE MINIMUM RECOMMENDED MOUNTING HEIGHT FOR REGULATION BASEBALL IS NO LESS THAN 7'
PPA - IF YOU HAVE AN EXTENDED FIELD OR SIDELINE THE PPA AVERAGE SHOULD BE SIMILAR TO THE OUTFIELD

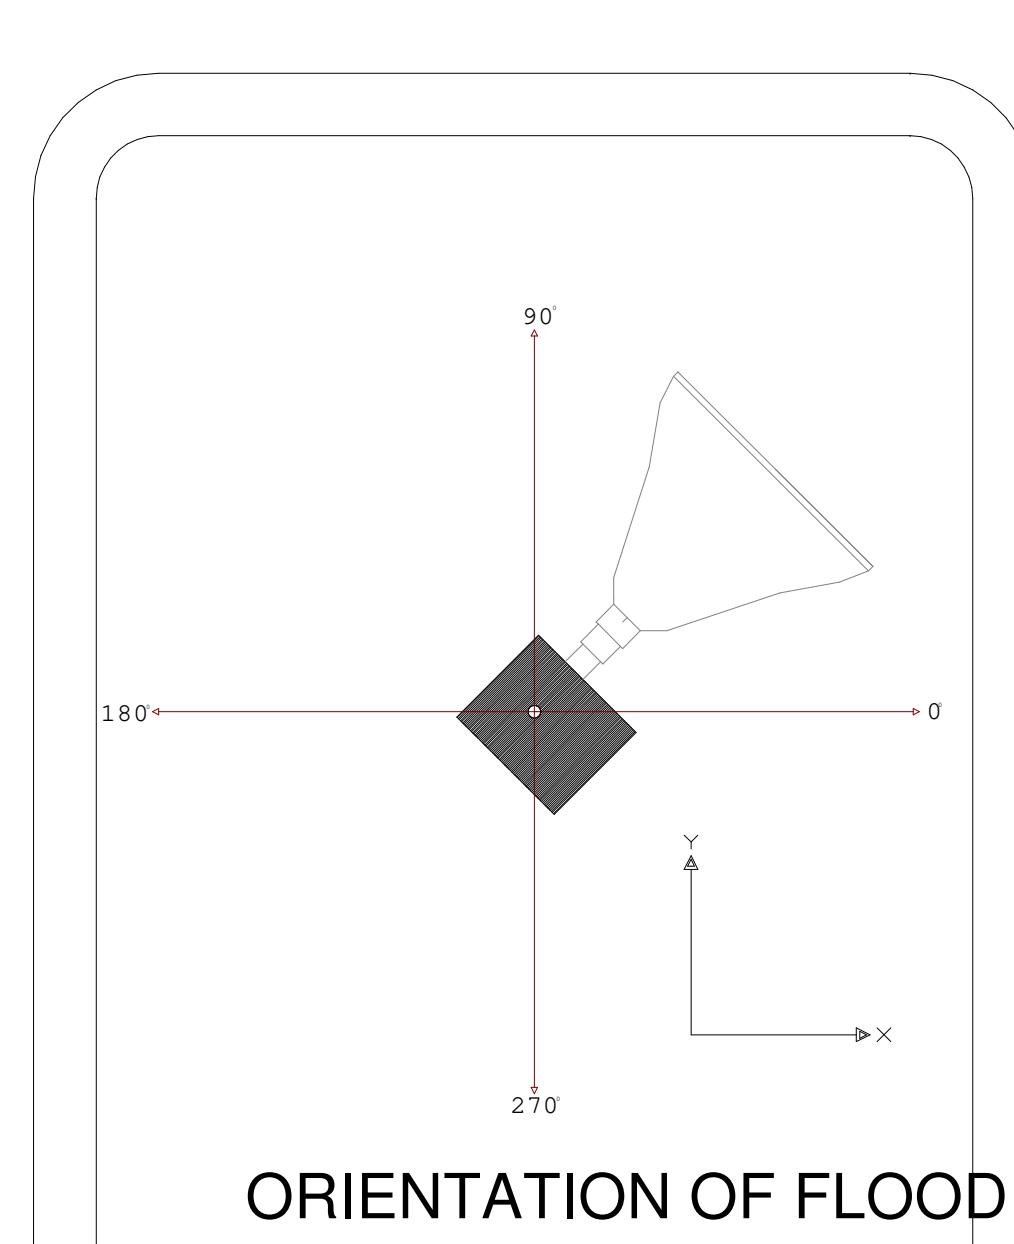

ORIENTATION OF FLOOD

Expanded Luminaire Location Summary									
Symbol	Label	X	Y	Z	Orient	Tilt	X-Angle	Y-Angle	
1	LS-1	-7	238	60	245.197	68	-52.379	123.234	
2	LS-1	-7	238	60	215.828	68	-119.362	121.497	
3	LS-1	-7	238	60	238.129	68	100.360	120.465	
4	LS-1	-7	238	60	238.129	68	100.360	120.465	
5	LS-1	-7	238	60	238.129	68	100.360	120.465	
6	LS-1	-7	238	60	238.129	68	100.360	120.465	
7	LS-1	-7	238	60	238.129	68	100.360	120.465	
8	LS-1	-7	238	60	234.233	66.745	-89	145	
9	LS-1	-7	238	60	301.87	56.687	84	245	
10	LS-1	-7	238	60	139.719	66.745	-89	145	
11	LS-1	-7	238	60	307.250	67.182	80	140	
12	LS-1	-7	238	60	259.155	60	-52.379	236.407	
13	LS-1	-7	238	60	212.455	68	-119.362	121.497	
14	LS-1	-7	238	60	238.129	68	100.360	120.465	
15	LS-1	-7	238	60	343.219	71	145.125	238.465	
16	LS-2	-7	238	60	308.619	71	155.271	194.301	
17	LS-2	-7	238	60	139.719	71	-119.362	120.465	
18	LS-1	0	41	60	139.719	71	-119.362	234.471	
19	LS-1	0	41	60	214.495	26.229	-39	34	
20	LS-1	0	41	60	139.719	66.745	-89	145	
21	LS-1	0	41	60	188.703	64.233	-122.399	9.1204	
22	LS-1	0	41	60	199.591	62.729	-109.460	21.392	
23	LS-1	0	41	60	139.719	66.745	-89	145	
24	LS-1	0	41	60	312.797	31.12	23	34	
25	LS-1	0	41	60	145.214	67.173	-119.498	141.309	
26	LS-1	0	41	60	139.719	66.745	-89	145	
27	LS-1	0	41	60	188.497	61.411	-109.399	42.194	
28	LS-1	0	41	60	139.719	66.745	-89	145	
29	LS-1	0	41	60	237.949	65.432	102.490	141.709	
30	LS-1	0	41	60	139.719	66.745	-89	145	
31	LS-1	243	23	60	148.511	64.051	119.367	145.169	
32	LS-1	243	23	60	148.511	64.051	119.367	145.169	
33	LS-1	243	23	60	139.719	66.745	-89	145	
34	LS-1	243	23	60	124.562	67.173	-119.498	152.523	
35	LS-1	243	23	60	139.719	66.745	-89	145	
36	LS-1	243	23	60	139.719	66.745	-89	145	
37	LS-2	243	23	60	110.153	67.173	-119.498	176	
38	LS-1	243	23	60	88.497	51.719	245	98	
39	LS-1	243	23	60	139.719	66.745	-89	145	
40	LS-1	61	0	60	137.203	31.12	24	25	
41	LS-1	61	0	60	137.203	61.411	-109.399	141.709	
42	LS-1	61	0	60	137.203	61.411	-109.399	141.709	
43	LS-1	61	0	60	137.203	61.411	-109.399	141.709	
44	LS-1	61	0	60	237.949	64.051	-109.399	141.709	
45	LS-1	61	0	60	139.719	66.745	-89	145	
46	LS-1	61	0	60	139.719	66.745	-89	145	
47	LS-1	61	0	60	139.719	66.745	-89	145	
48	LS-1	61	0	60	139.719	66.745	-89	145	
49	LS-1	61	0	60	137.203	59.453	-119.498	35.392	
50	LS-1	61	0	60	137.203	61.411	-109.399	141.709	
51	LS-1	61	0	60	146.255	62.498	-109.399	145.324	
52	LS-1	61	0	60	139.719	66.745	-89	145	
53	LS-1	61	0	60	95.315	64.051	-109.399	141.709	
54	LS-1	61	0	60	110.714	65.432	-109.399	141.709	
55	LS-1	61	0	60	139.719	66.745	-89	145	
56	LS-1	61	0	60					

Luminaire Schedule						
Symbol	Qty	Label	Arrangement	Lum. Lumen	LIF	Description
LS-2	8	LS-2	SINGLE	90985	0.950	EPH-08-0440L-57-70-28-BEG
LS-3	16	LS-3	SINGLE	89640	0.950	EPH-08-0440L-57-70-38-BEG
LS-5	4	LS-5	SINGLE	90904	0.950	EPH-08-0440L-57-70-58-BEG

Calculation Summary									
Label	CaloType	Units	Avg	Max	Min	Avg/Min	Max/Min	Grid Z	
FIELD @ 3' ABOVE GRADE	Illuminance	Fc	37.80	65.8	19.3	1.96	3.41	3	
Spill Light @ Grade	Illuminance	Fc	0.89	6.1	0.2	4.45	30.50	0	
INFIELD 1	Illuminance	Fc	51.38	65.8	35.7	1.44	1.84		
OUTFIELD 1	Illuminance	Fc	33.04	44.7	19.3	1.71	2.32		


SOFTBALL IES RP-6-15
*DEFINED INFELD AREA IS EXTENDED TO INCLUDE THE SPACE FROM THE BASELINE TO THE FENCE

MINIMUM POLE HEIGHTS (RULE OF THUMB)

A POLES - BASELINE@9' + SETBACK/2
B POLES - DISTANCE STRAIGHT TO DIAGONAL/3
C POLES - LONGEST AIMING VECTOR/2


*THE MINIMUM RECOMMENDED MOUNTING HEIGHT FOR REGULATION BASEBALL IS NO LESS THAN 70'

PPA - IF YOU HAVE AN EXTENDED INFELD OR SIDELINE THE PPA AVERAGE SHOULD BE SIMILAR TO THE OUTFIELD

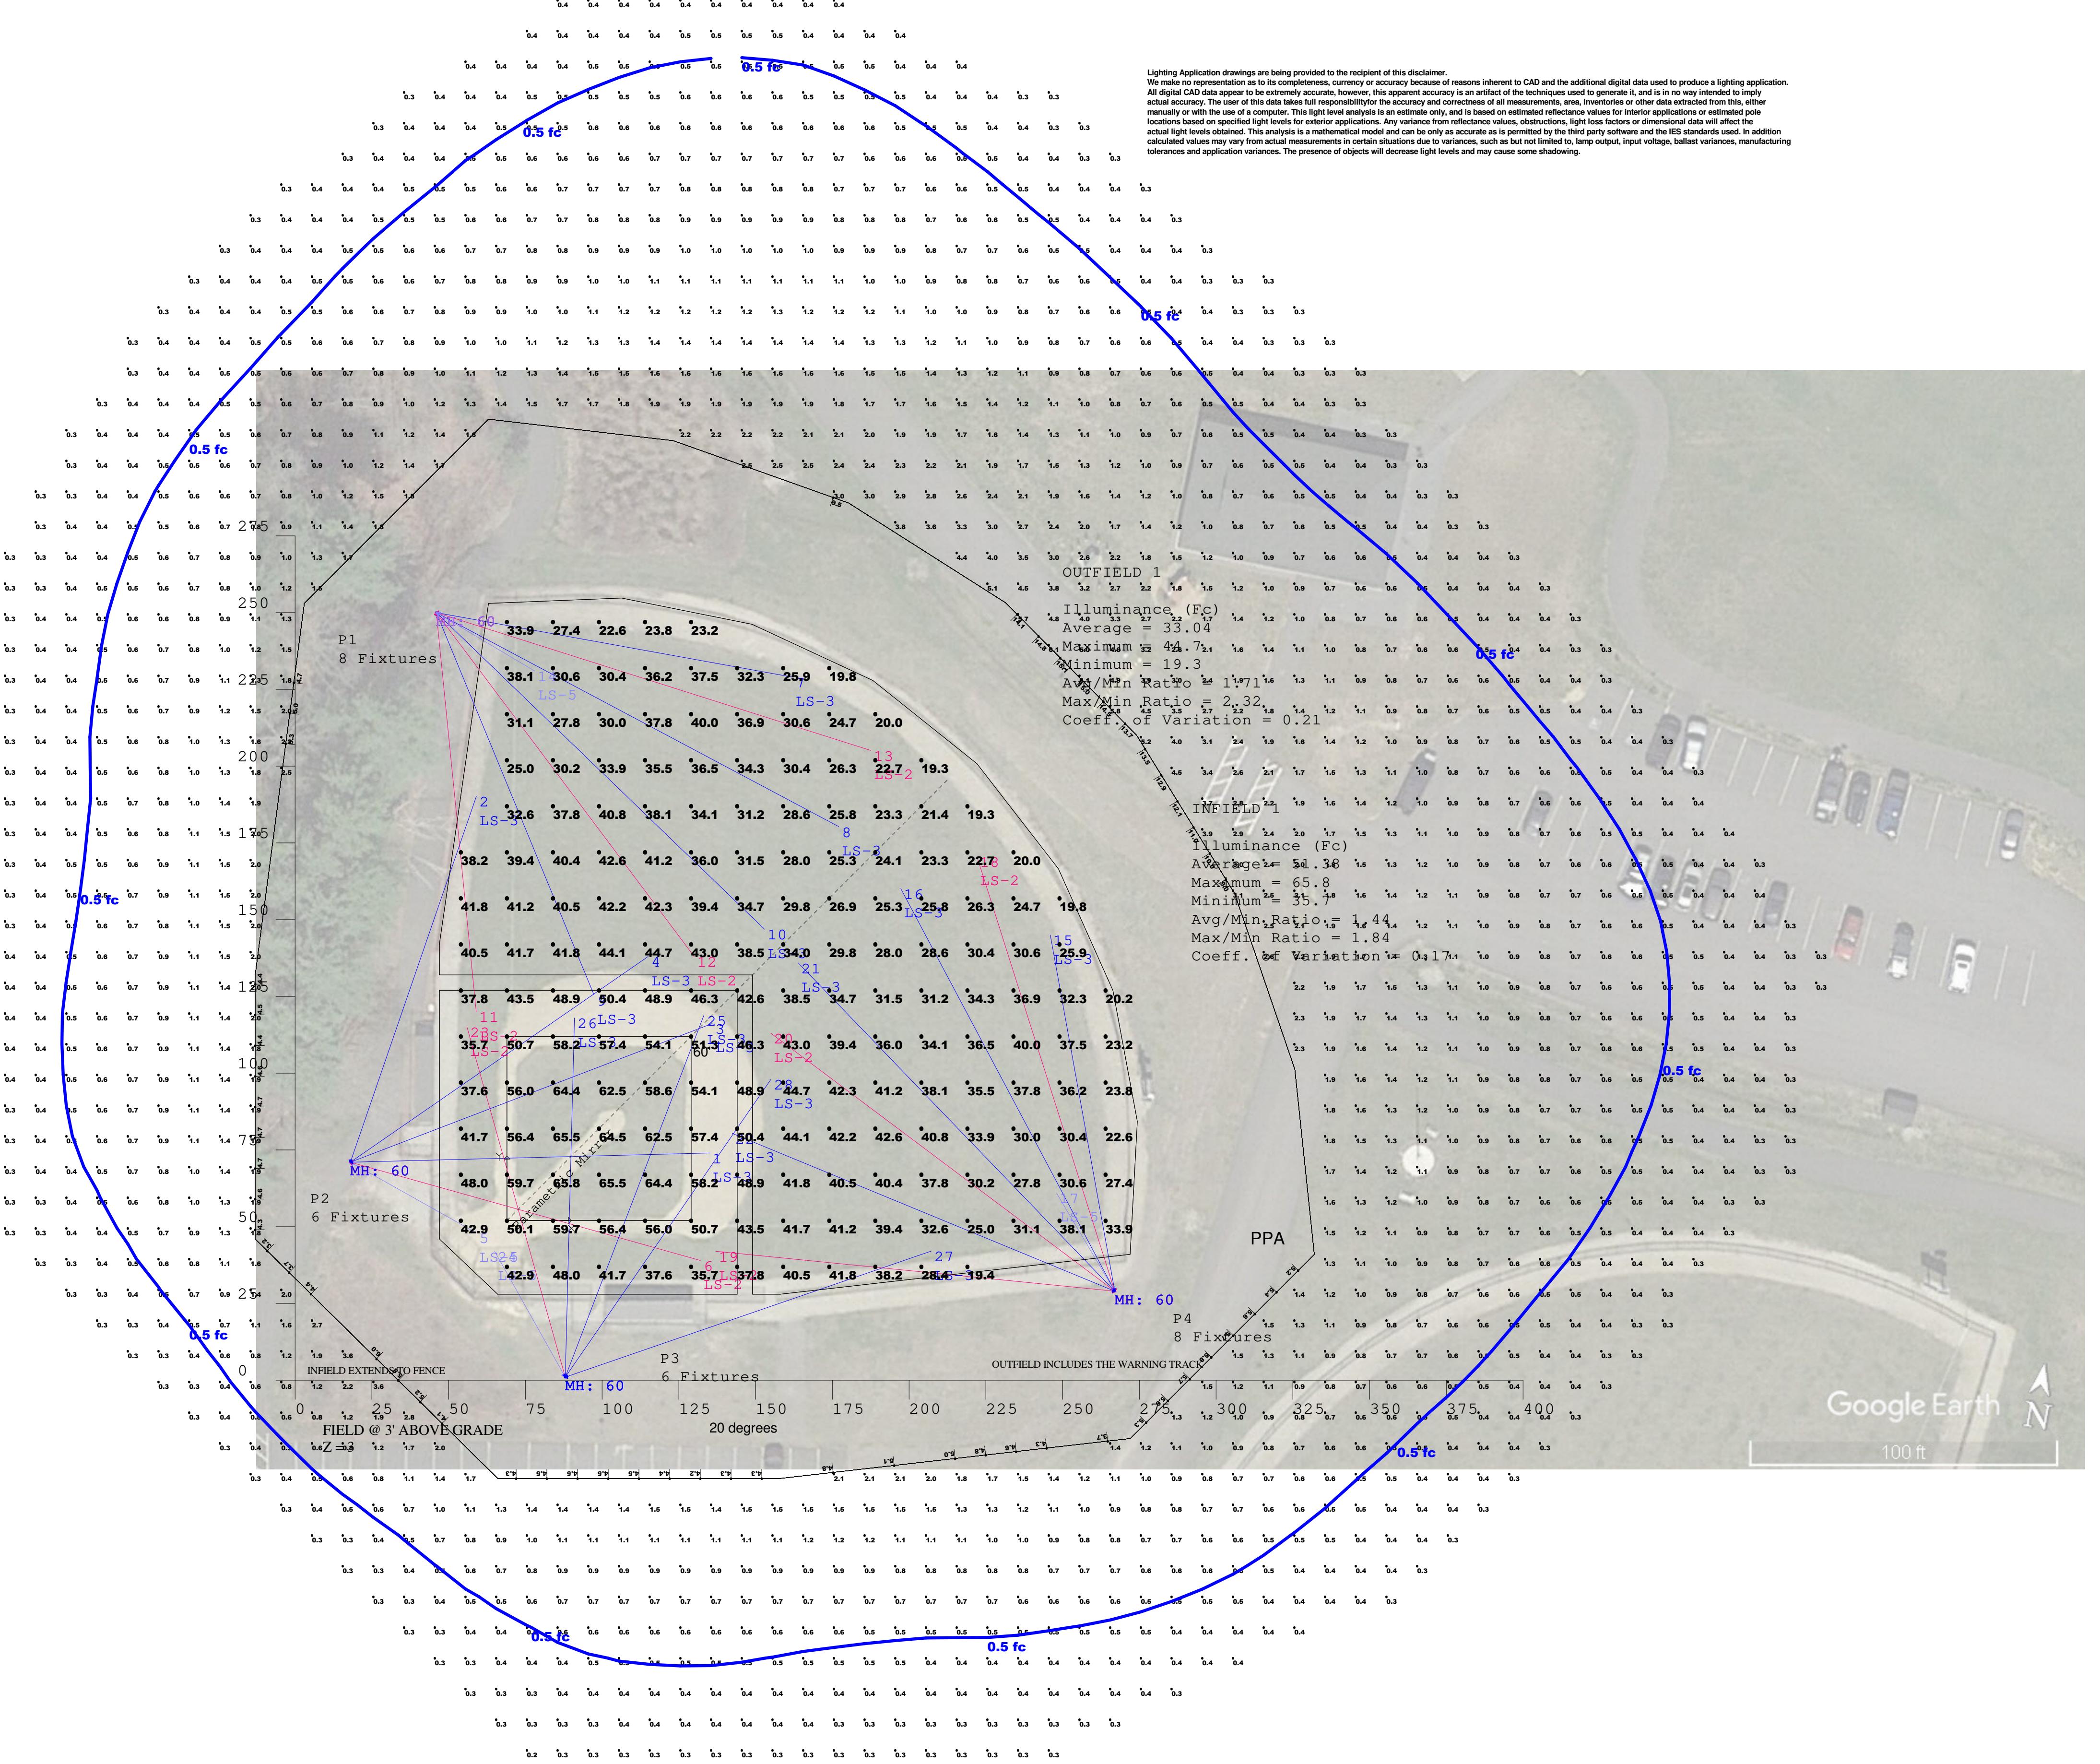


Expanded Luminaire Location Summary								
LumNo	Label	x	y	z	Orient	Tilt	X-Azimp	Y-Azimp
1	LS-3	18	73	60	1,469	62,858	135	74
2	LS-3	18	73	60	70,989	64,552	59,073	190,21
3	LS-3	18	73	60	20,973	64,571	135,834	116,169
4	LS-3	18	73	60	34,634	63,026	115	138
5	LS-5	18	73	60	330,709	38,079	59	48
6	LS-2	18	73	60	344,32	63,127	132	39
7	LS-3	46	250	60	349,739	63,025	162	229
8	LS-3	46	250	60	331,998	68	177,12	180,276
9	LS-3	46	250	60	292,426	66,001	97,413	125,424
10	LS-3	46	250	60	316,042	68	152,901	146,918
11	LS-2	46	250	60	275,711	65,333	59	120
12	LS-2	46	250	60	306,87	66,8	129,995	138,008
13	LS-2	46	250	60	342,399	68	187,553	205,094
14	LS-5	46	250	60	329,3	31,81	78	231
15	LS-3	267	29	60	100,261	63,025	246	145
16	LS-3	267	29	60	118,022	68	197,276	160,12
17	LS-5	267	29	60	120,7	31,81	248	41
18	LS-2	267	29	60	107,401	68	222,094	170,553
19	LS-2	267	29	60	174,289	65,333	137	42
20	LS-2	267	29	60	143,13	66,8	155,008	112,995
21	LS-3	267	29	60	133,958	68	163,918	135,901
22	LS-3	267	29	60	157,574	66,001	142,424	80,413
23	LS-2	88	1	60	105,68	63,127	56	115
24	LS-5	88	1	60	119,291	38,079	65	42
25	LS-3	88	1	60	69,027	64,571	133,169	118,834
26	LS-3	88	1	60	88,531	62,858	91	118
27	LS-3	88	1	60	13,011	64,552	207,21	42,073
28	LS-3	88	1	60	55,166	63,026	155	98


Total Quantity: 28

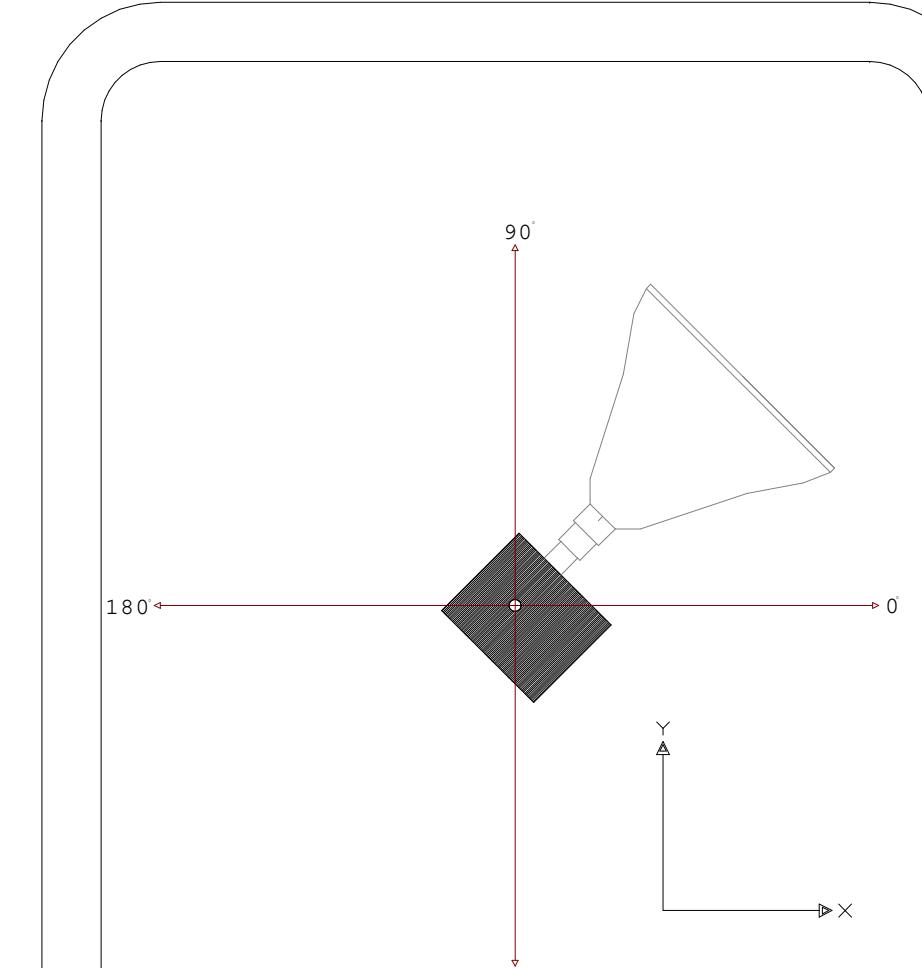

ORIENTATION OF FLOOD

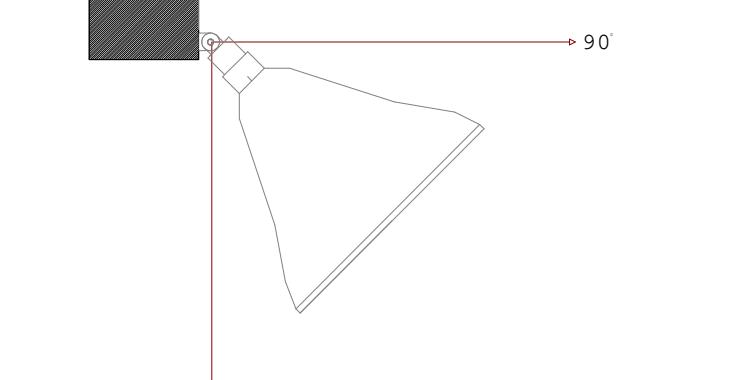

TIILT OF FLOOD

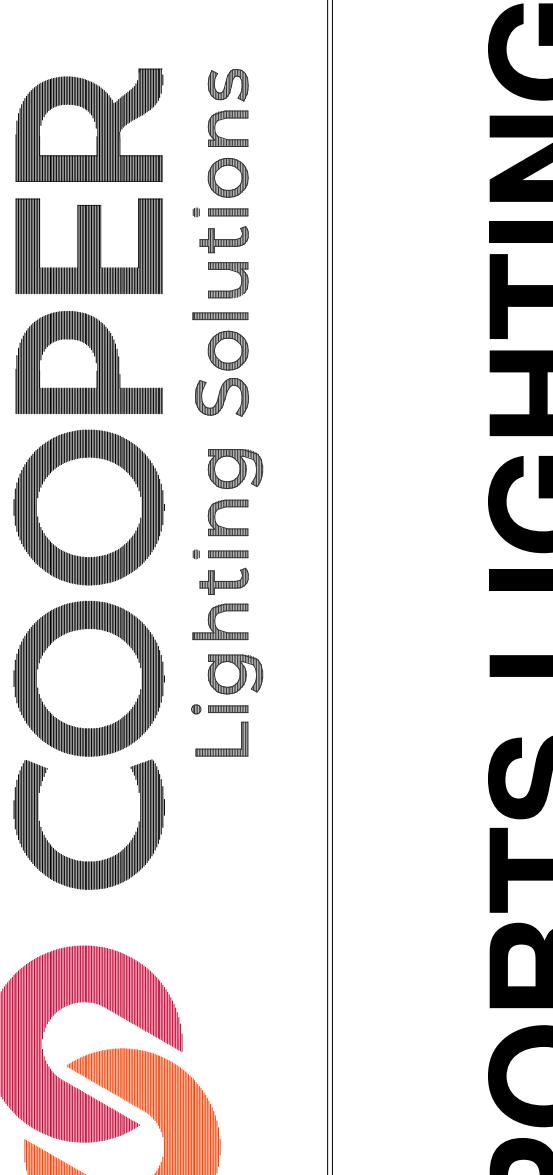




SPORTS LIGHTING

Client:
Ed Columbo
Reflex Lighting Group

Project Name:
EPH Forge
Park Fields

Project #: 2101485r3.2.AGI
Drawing by:
Date: 1/24/2023
Scale: 1" = 30'
JR

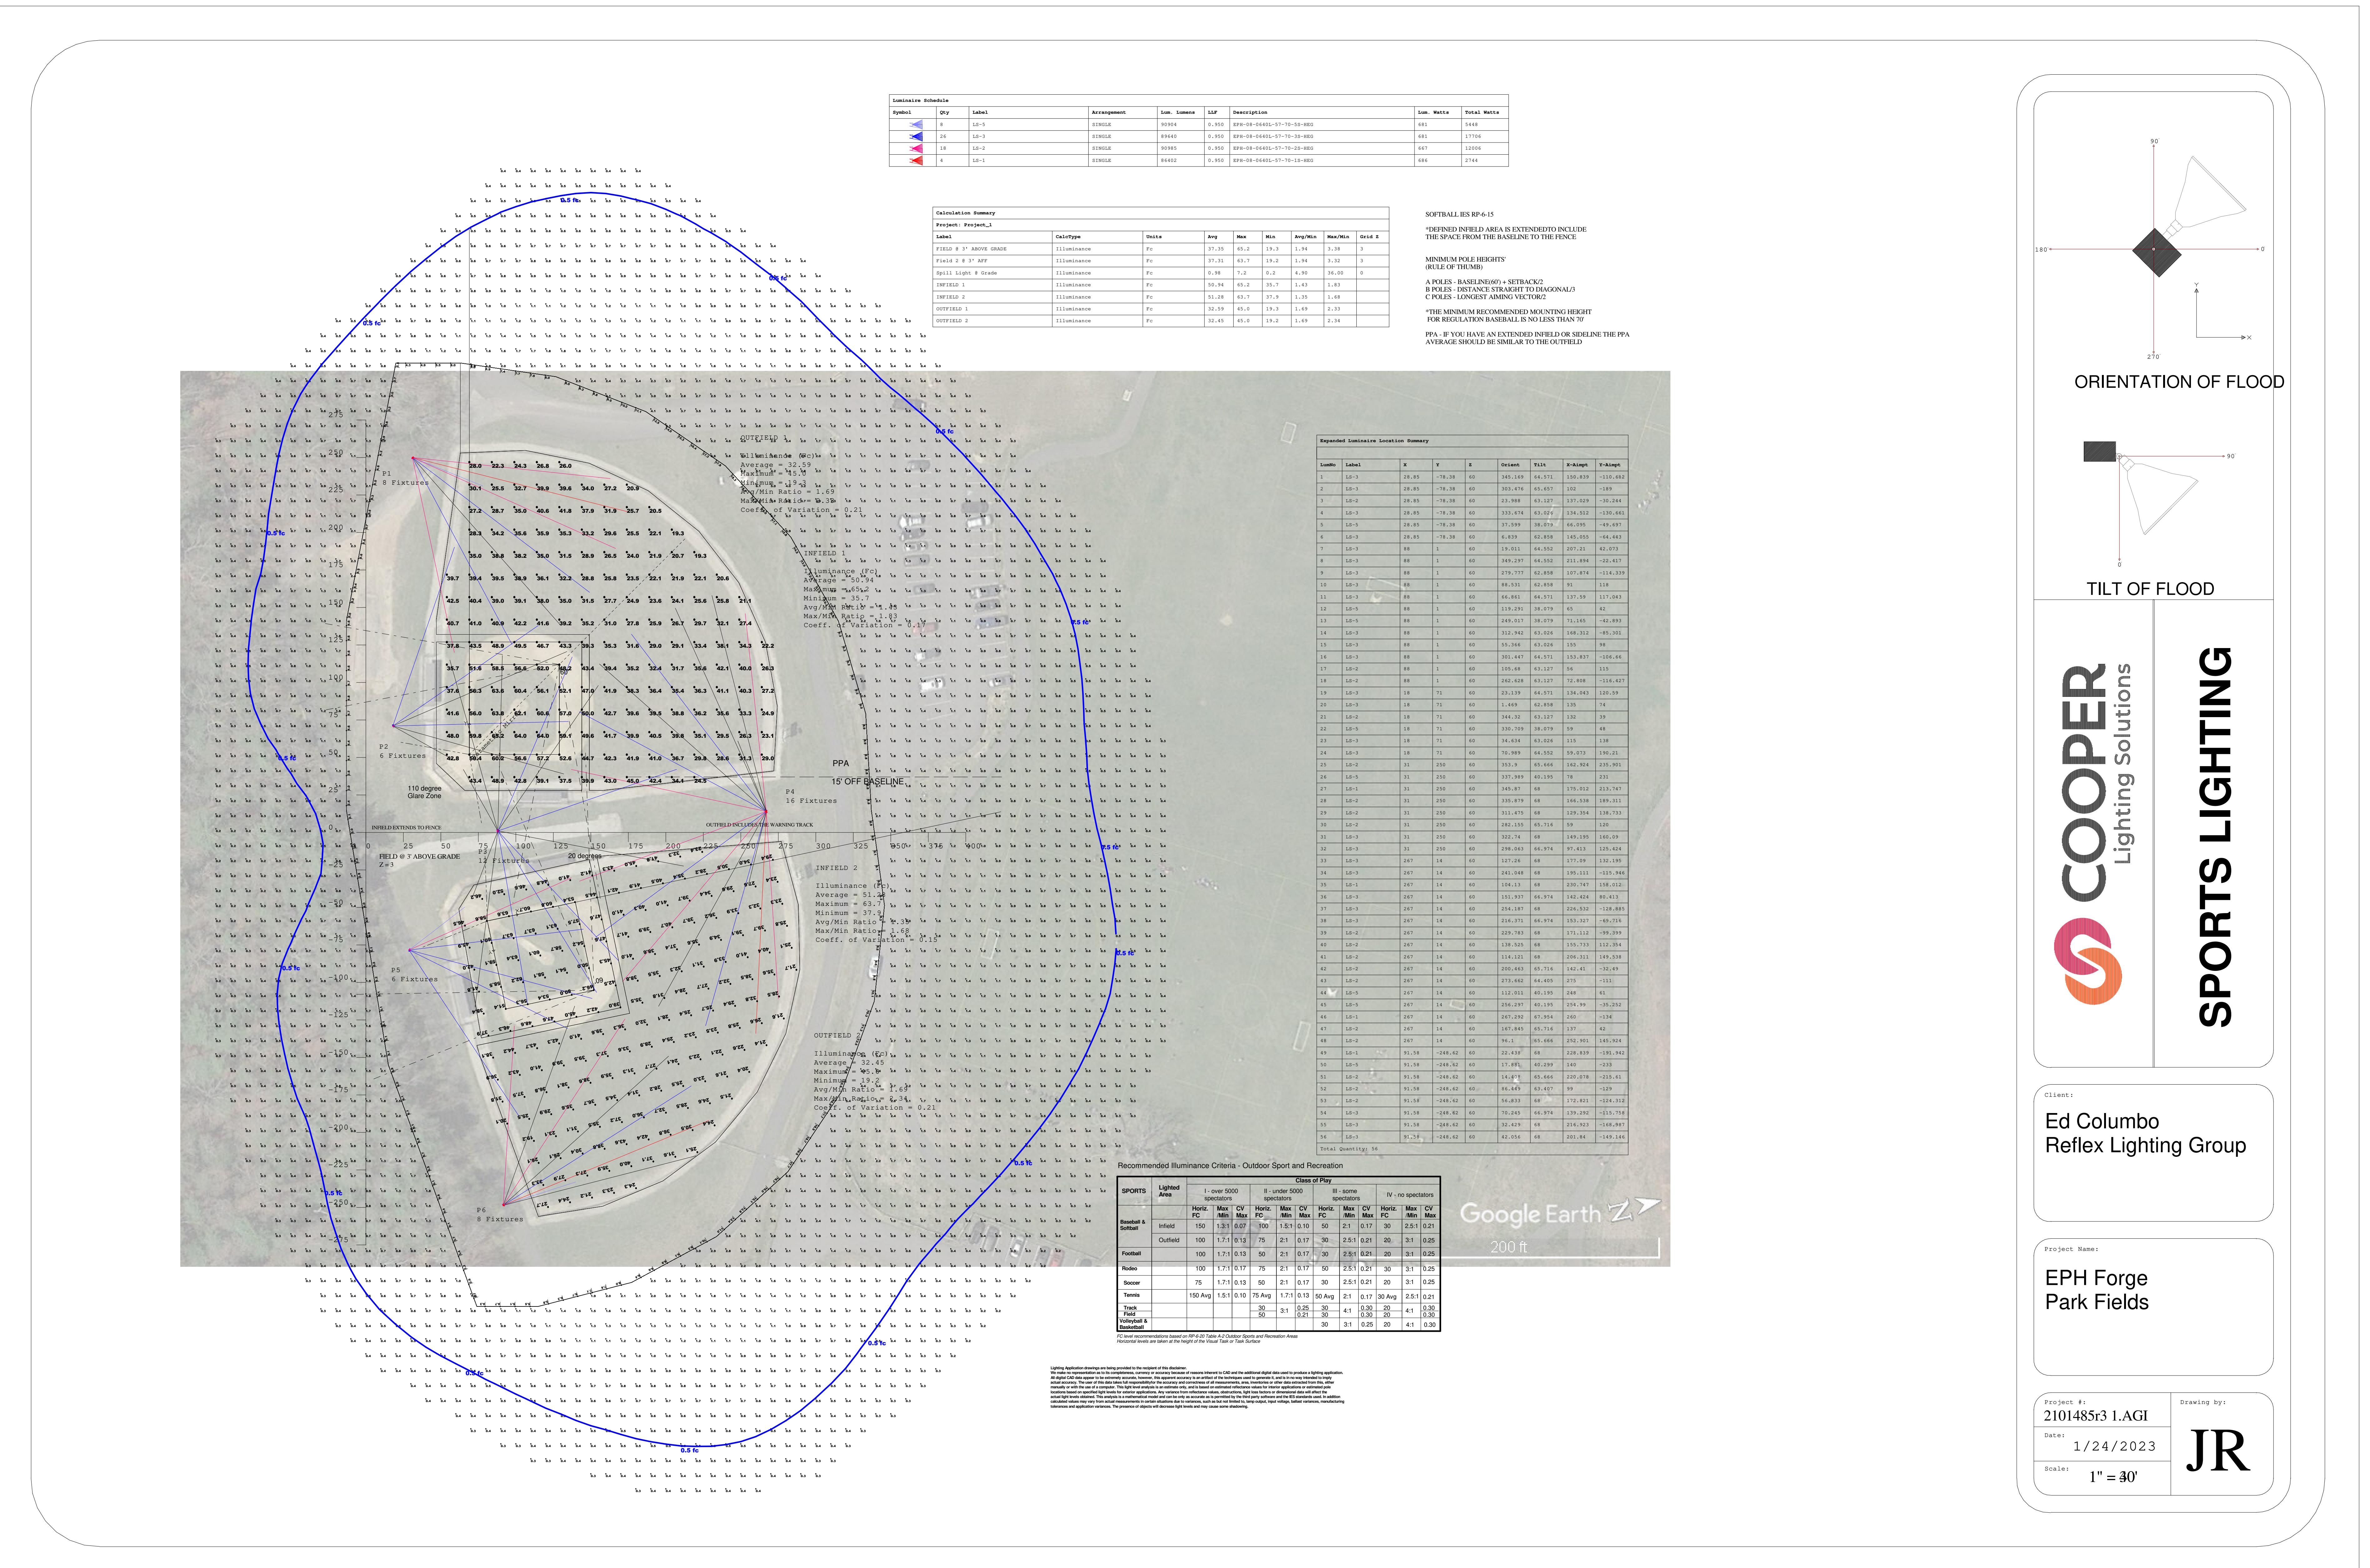

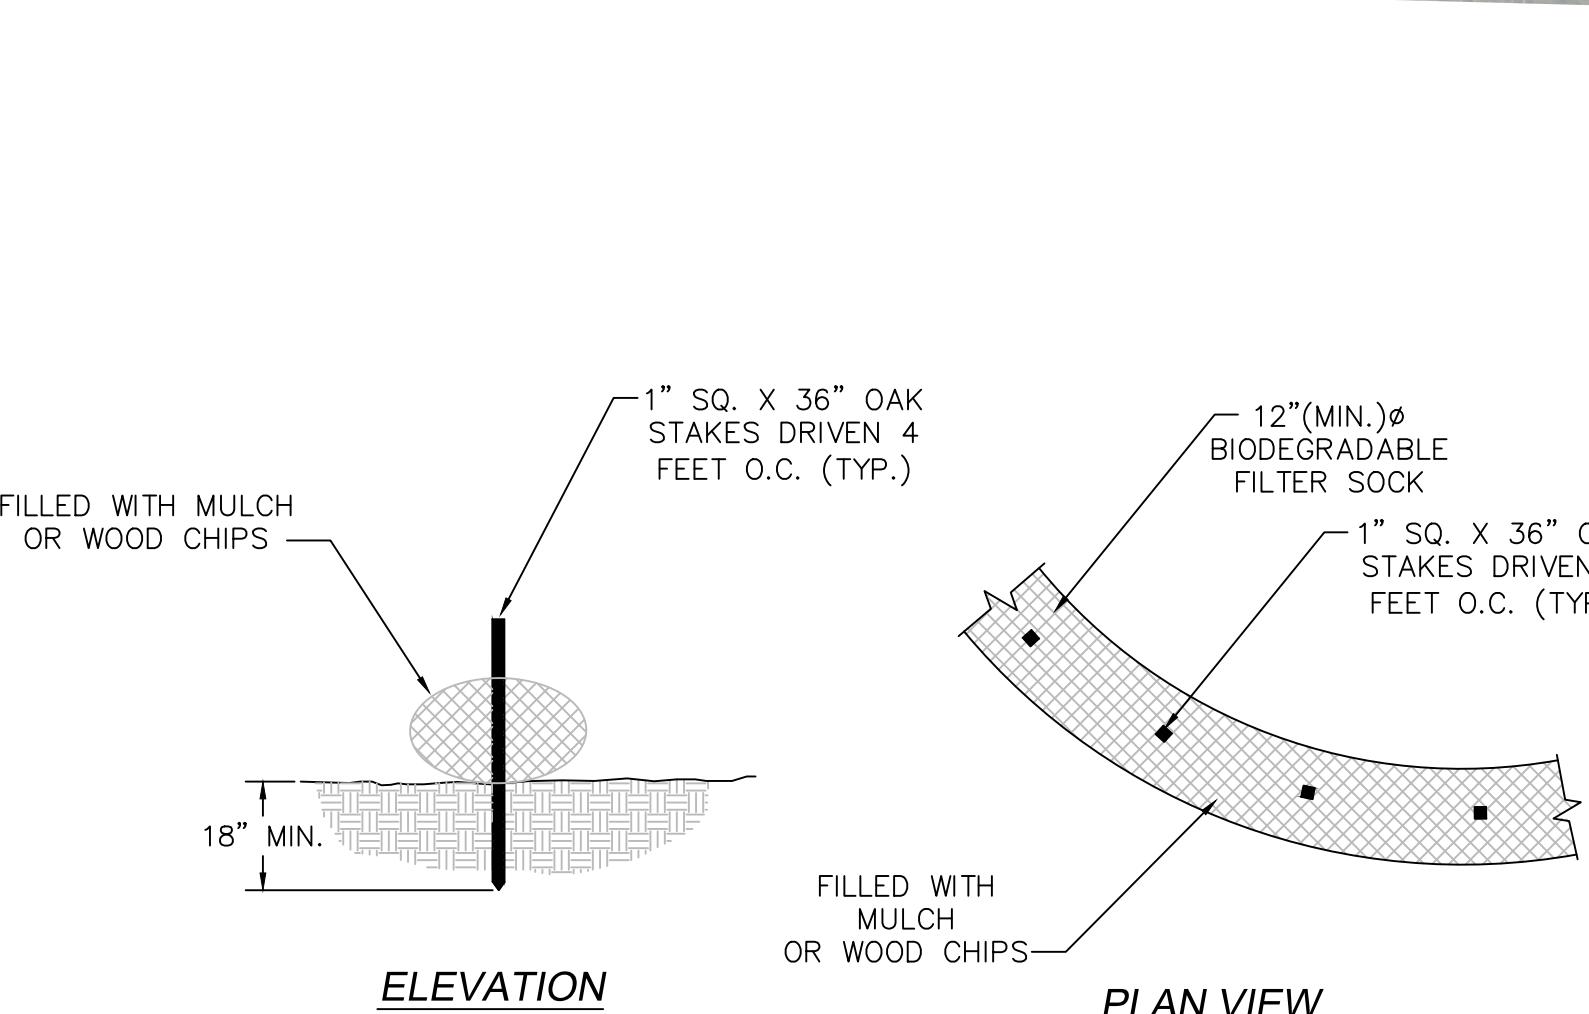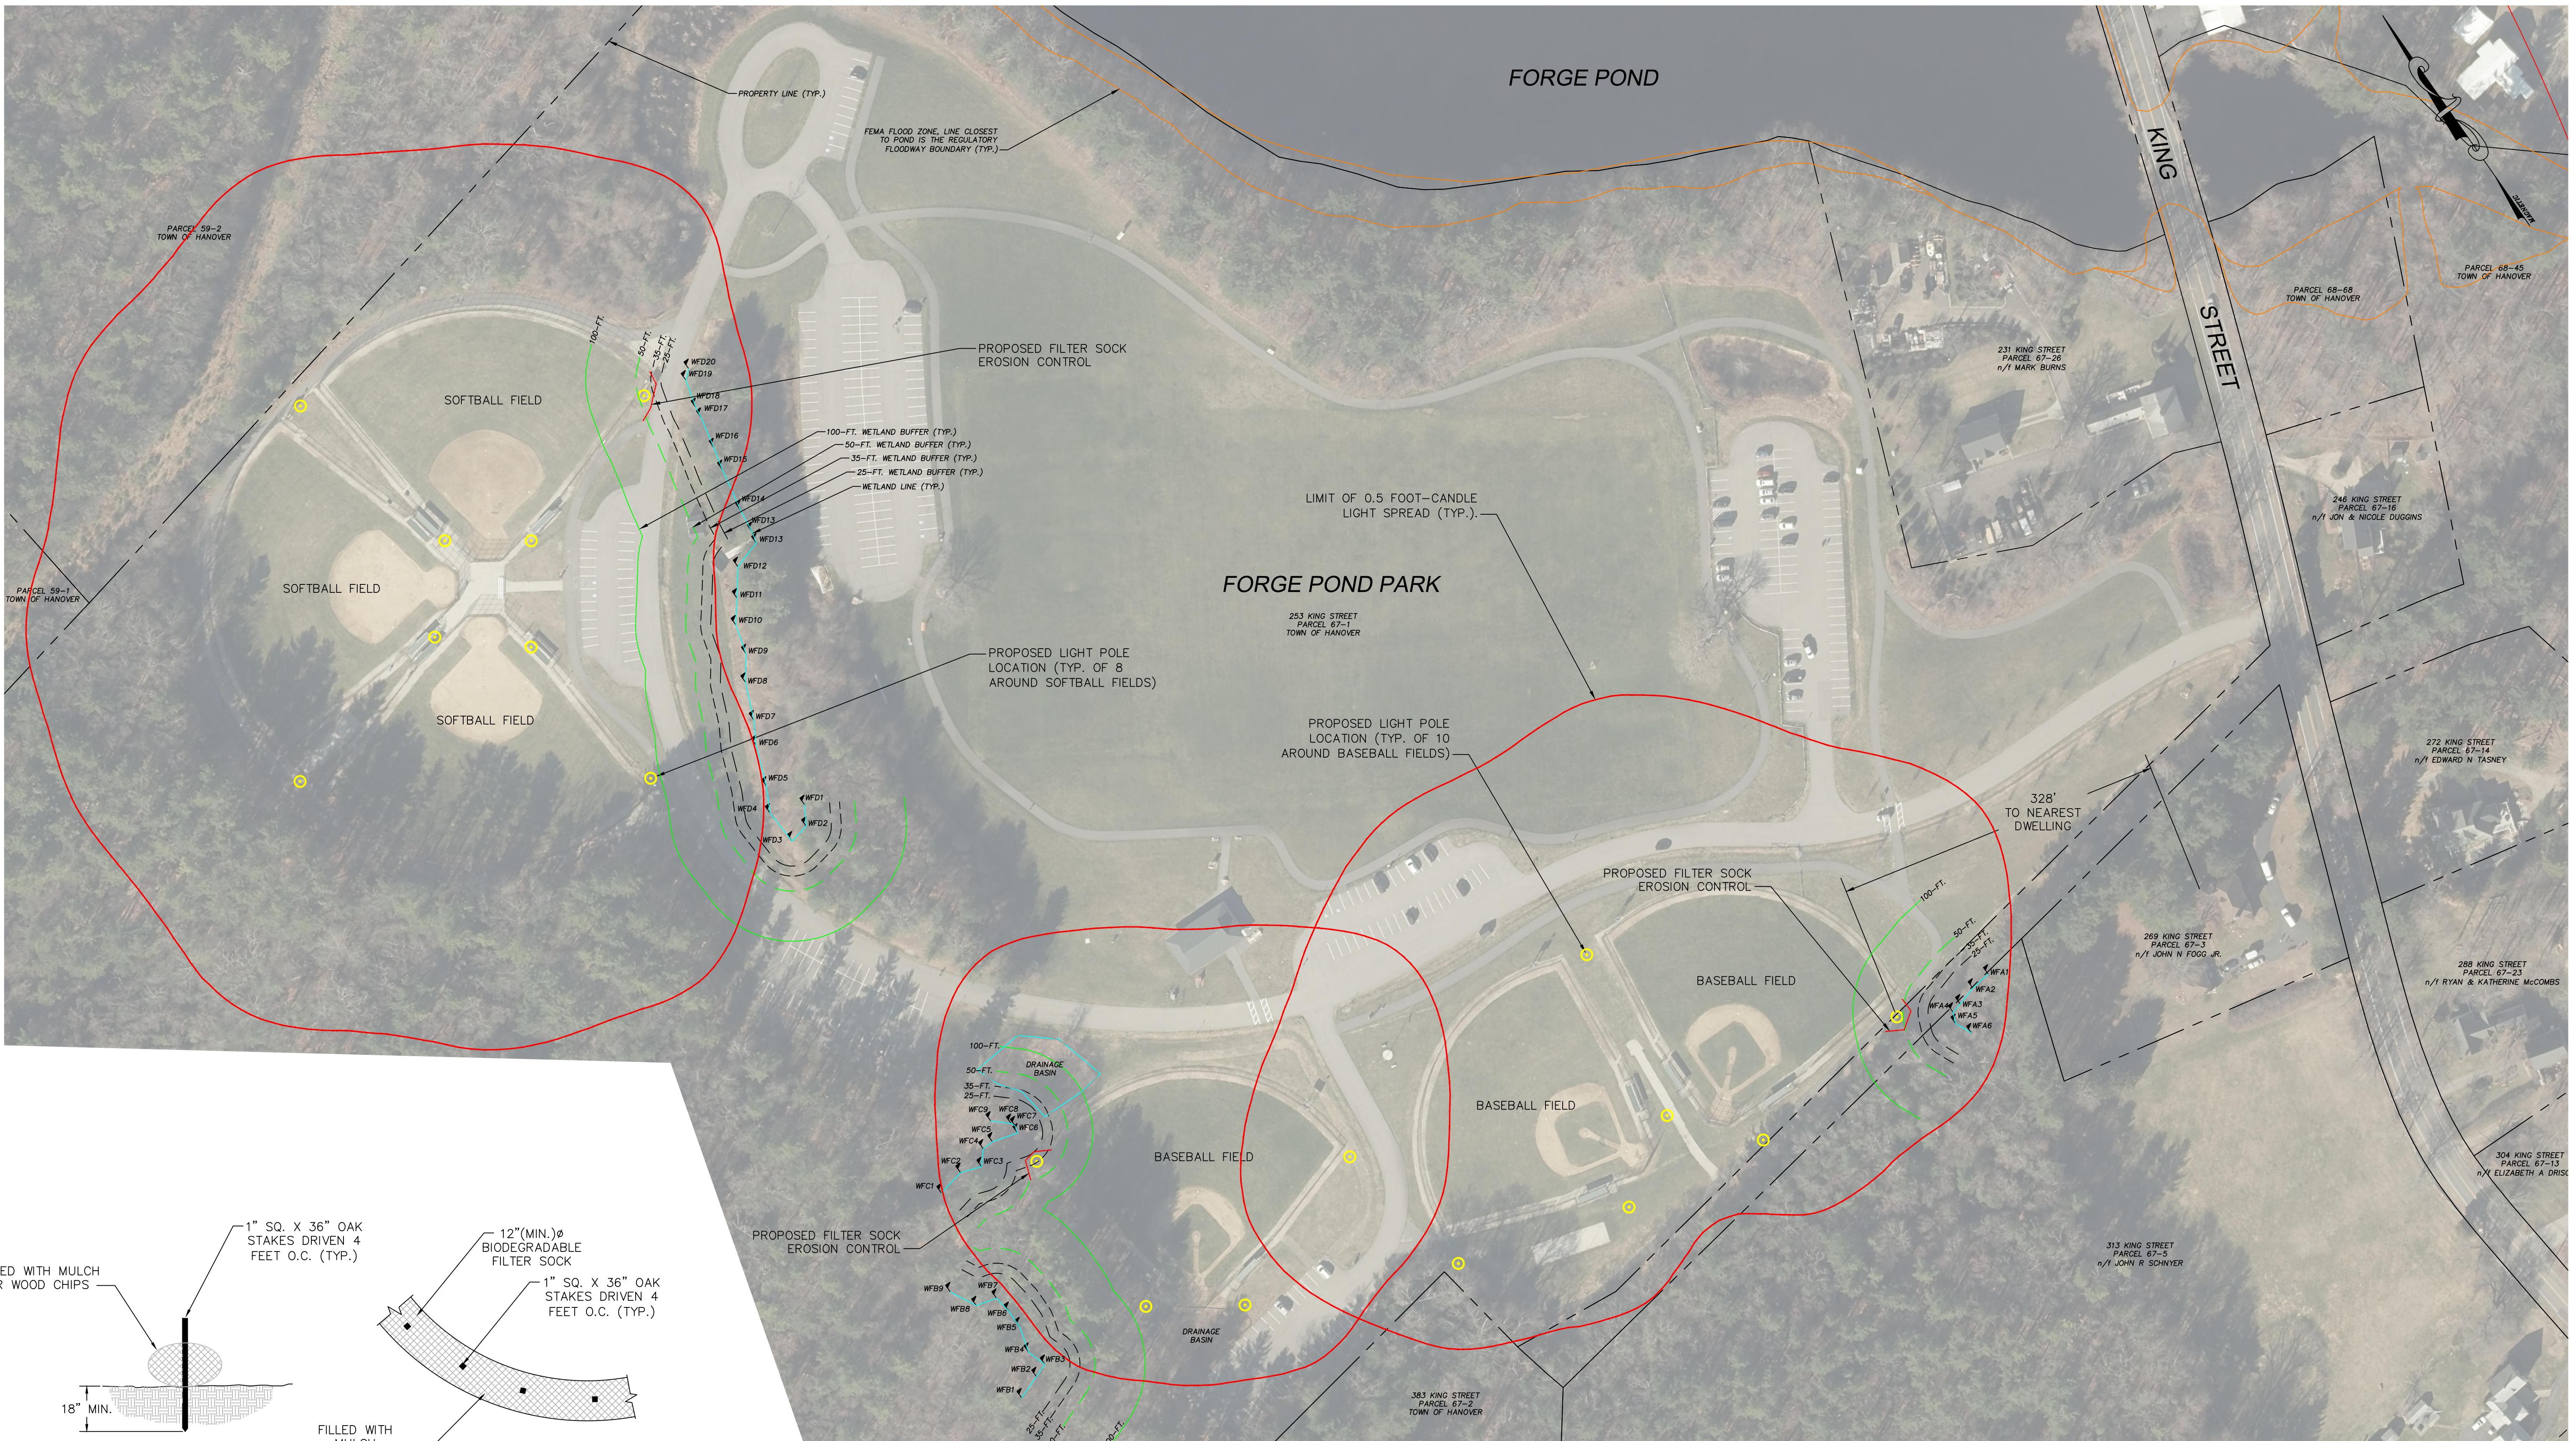

- NOTES:**
1. FILTER SOCK SHALL BE PLACED PRIOR TO START OF WORK.
 2. OAK STAKES SHALL BE DRIVEN AT LEAST 18" MIN. INTO NATIVE SOIL.
 3. FILTER SOCK SHALL BE PLACED AT THE LOCATIONS SHOWN BEFORE ANY EXCAVATION OR EARTH MOVING OPERATIONS.

FILTER SOCK DETAIL

NOT TO SCALE

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REVISIONS		
NO.	ITEM	DATE
1.	ISSUED FOR PERMITS	2/9/23
<i>PATRICK G. BRENNAN</i> AMORY ENGINEERS, P.C. CIVIL No. A1489 MASSACHUSETTS STATE OF ENGINEERS DATE: FEBRUARY 9, 2023		
DRAWN BY: PGB DESIGNED BY: PGB CHECKED BY: PGB		

PGB ENGINEERING, LLC		
MARSHFIELD, MASSACHUSETTS		
DRAWN BY: PGB	FILE NAME: AS SHOWN	SCALE: AS SHOWN
DESIGNED BY: PGB	JOB NO.: 23-127	DWG. NO.: **
CHECKED BY: PGB	DATE: 2/9/23	CONTRACT: **

DEPARTMENT OF PUBLIC WORKS HANOVER, MASSACHUSETTS	CIVIL
PROPOSED SPORTS FIELD LIGHTING AT FORGE POND PARK SITE PLAN	SHEET 1 OF 1