

# Drawing Index:

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#### Owners

Anthony McSharry 6 Leah Drive, Rear Rockland, MA 02370

**PLAN** 

Ursula B. Stone, Trustee Stone II Realty Trust 58 Oakland Avenue Hanover, MA 02339

Cardinal Cushing School & Training Center 405 Washington Street Hanover, MA 02339

### Applicant:

32 Oakland Ave LLC 30 Wade Way Hanover, MA 02339

## Engineer/Surveyor:


McKenzie Engineering Group, Inc. 150 Longwater Drive Suite 101 Norwell, MA 02061

# OAKLAND ESTATES


(Assessors Map 49, Portions of Lots 1 & 2, Map 57, Lot 31)

# Definitive Subdivision Plan

Hanover, Massachusetts

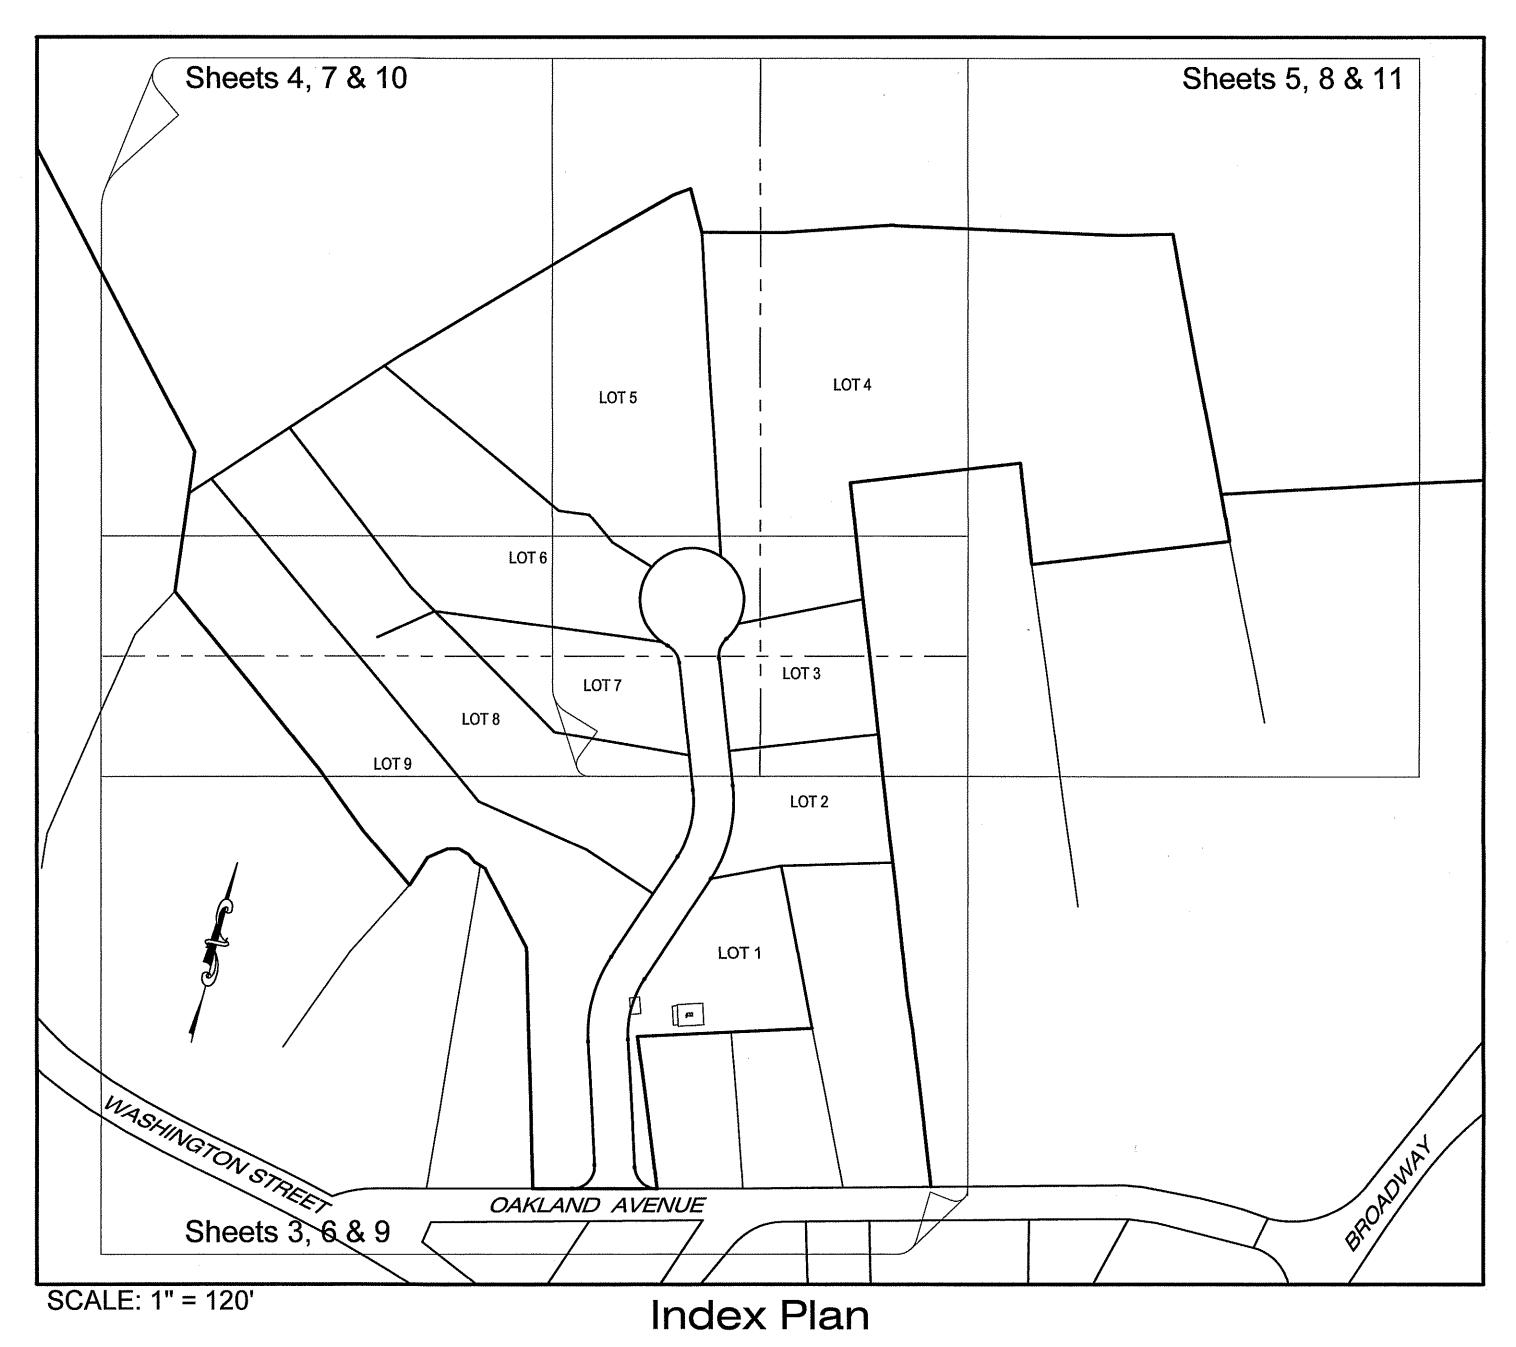


Issued Date: December 14, 2020 Revised: January 21, 2021 Revised: March 11, 2021

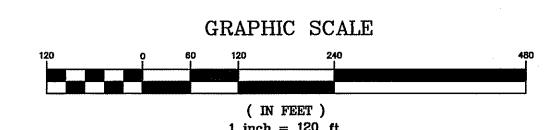

McKenzie Engineering Group, Inc. Consulting Engineers 150 Longwater Drive, Suite 101, Norwell, Massachusetts 02061

FOR REGISTRY USE ONLY

BRADLEY C. MCKENZIE, P.E. MCKENZIE ENGINEERING GROUP, INC.

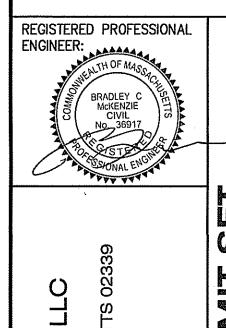

**DESIGNED BY:** AWL CHECKED BY: BY: BCM
DECEMBER 14, 2020 APPROVED BY: PROJECT NO.:

DWG. TITLE: Cover Sheet

DWG. No:

© MCKENZIE ENGINEERING GROUP, INC FILE LOCATION: M: \217-106\DWGS\DWGS-Definitive\217-106 Definitive.dwg

Abbreviations  Existing Proposed Description  A CACCOUNT CACADA  A CACCOUNT CACCOUNT CACADA  A CACCOUNT CACCOUNT CACADA  A CACCOUNT CACCOUNT CACADA  A CACCOUNT CAC	
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12. NHESP: THE SUBJECT PROPERTY DOES NOT FALL WITHIN THE NAT ENDANGERED SPECIES PROGRAM PRIORITY HABITAT AS SH MASSGIS.	

### - I N I \_ L \_

HANOVER ASSESSOR'S MAP 49

CONJUNCTION OR MAKES NO COMPRISE ALL THE LAND UTILITIES ES CERTIFY AILABLE INFORMATION Y LOCATED THE YSTEMS, INC. AT

FOR REGISTRY USE ONLY

I HEREBY CERTIFY THAT THIS PLAN CONFORMS TO THE RULES AND REGULATIONS OF THE REGISTERS OF DEEDS DATED JANUARY 2, 1976 AND REVISED JANUARY 12, 1988.

BRADLEY C. MCKENZIE, P.E. MCKENZIE ENGINEERING GROUP, INC.

CLERK OF THE TOWN OF HANOVER, HEREBY CERTIFY THAT THE NOTICE OF APPROVAL OF THIS PLAN BY THE PLANNING BOARD Was received on \_\_\_\_ THIS OFFICE NO NOTICE OF APPEAL WAS RECEIVED DURING THE TWENTY DAYS NEXT FOLLOWING SUCH RECEIPT AND RECORDING OF SAID NOTICE.

DATE	IOWN	CLER	K		
APPROVED_		S	UBJECT	ТО	COVENANT
CONDITIONS					

BY \_\_\_\_\_\_, DATED \_\_\_\_ AND TO BE RECORDED HEREWITH. APPROVAL UNDER THE SUBDIVISION CONTROL LAW REQUIRED

DATE OF APPLICATION:

DATE OF HEARING:

DATE OF APPROVAL:

DATE OF ENDORSEMENT: \_\_\_\_

M C K E N Z I E ENGINEERING GROUP

31)

Assinippi Office Park

P: 781.792.3900

F: 781.792.0333 www.mckeng.com

150 Longwater Drive, Suite 101 Norwell, MA 02061

CHECKED BY: APPROVED BY:

SCALE:
PROJECT NO.:
DWG. TITLE:

General Notes, Legend, Symbols & Abbreviations

List of Waivers Requested from the Rules and Regulations Governing the Subdivision of Land in Hanover Massachusetts (June 1998)

1. SECT. IV.A.1.b: STREETS, LOCATION

REQUIRED: "PROVISION SATISFACTORY TO THE PLANNING BOARD SHALL BE MADE FOR THE PROPER PROJECTION OF STREETS, OR FOR ACCESS TO ADJOINING PROPERTY WHICH IS NOT YET SUBDIVIDED."

PROVIDED: NO PROJECTION OF STREET TO ADJOINING PROPERTY.

2. SECT. V.C.1: SIDEWALKS


REQUIRED: "PAVED SIDEWALKS SHALL BE CONSTRUCTED ALONG THE FULL LENGTH OF BOTH SIDES OF EVERY SUBDIVISION WAY..."


PROVIDED: ONE SIDEWALK IS PROVIDED.


3. TYPICAL ROADWAY SECTION


REQUIRED: "TYPICAL ROADWAY SECTION" AS SHOWN IN THE TOWN OF HANOVER RULES AND REGULATIONS GOVERNING THE SUBDIVISION OF LAND IN HANOVER, MASSACHUSETTS PROVIDED: PROPOSED RETAINING WALL SHOWN WITHIN THE PROPOSED RIGHT OF WAY AT THE BACK EDGE OF SIDEWALK.




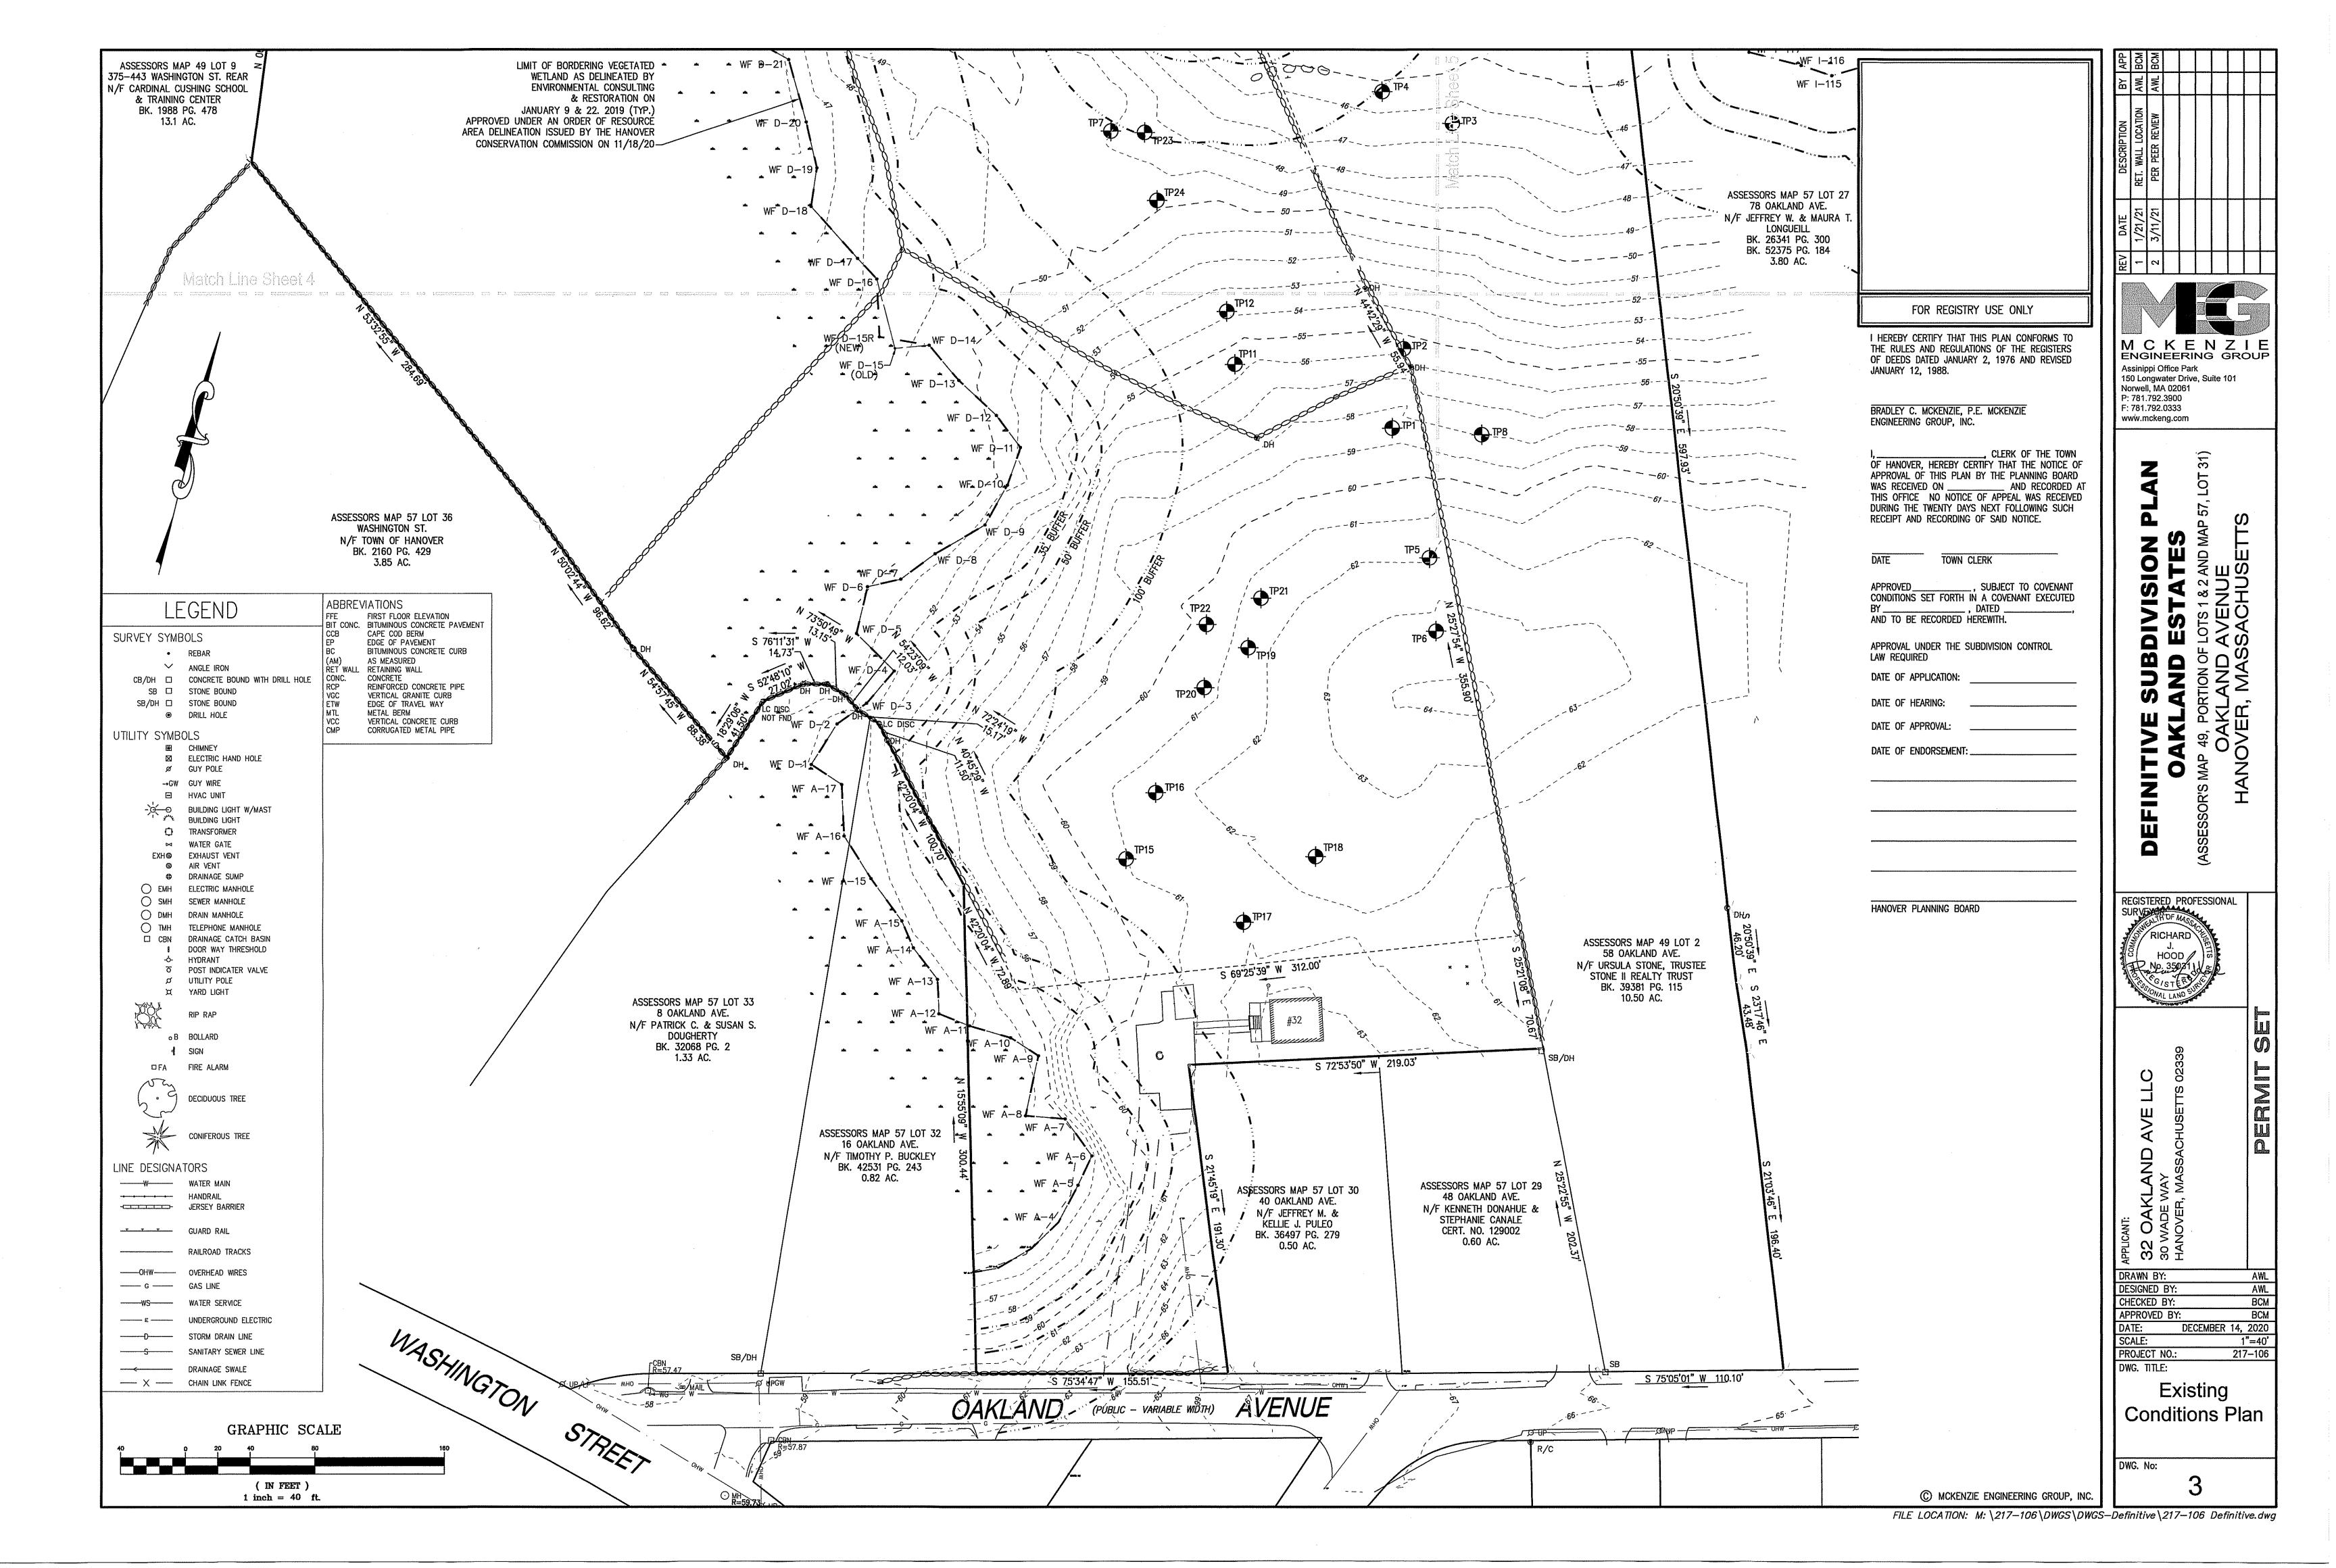


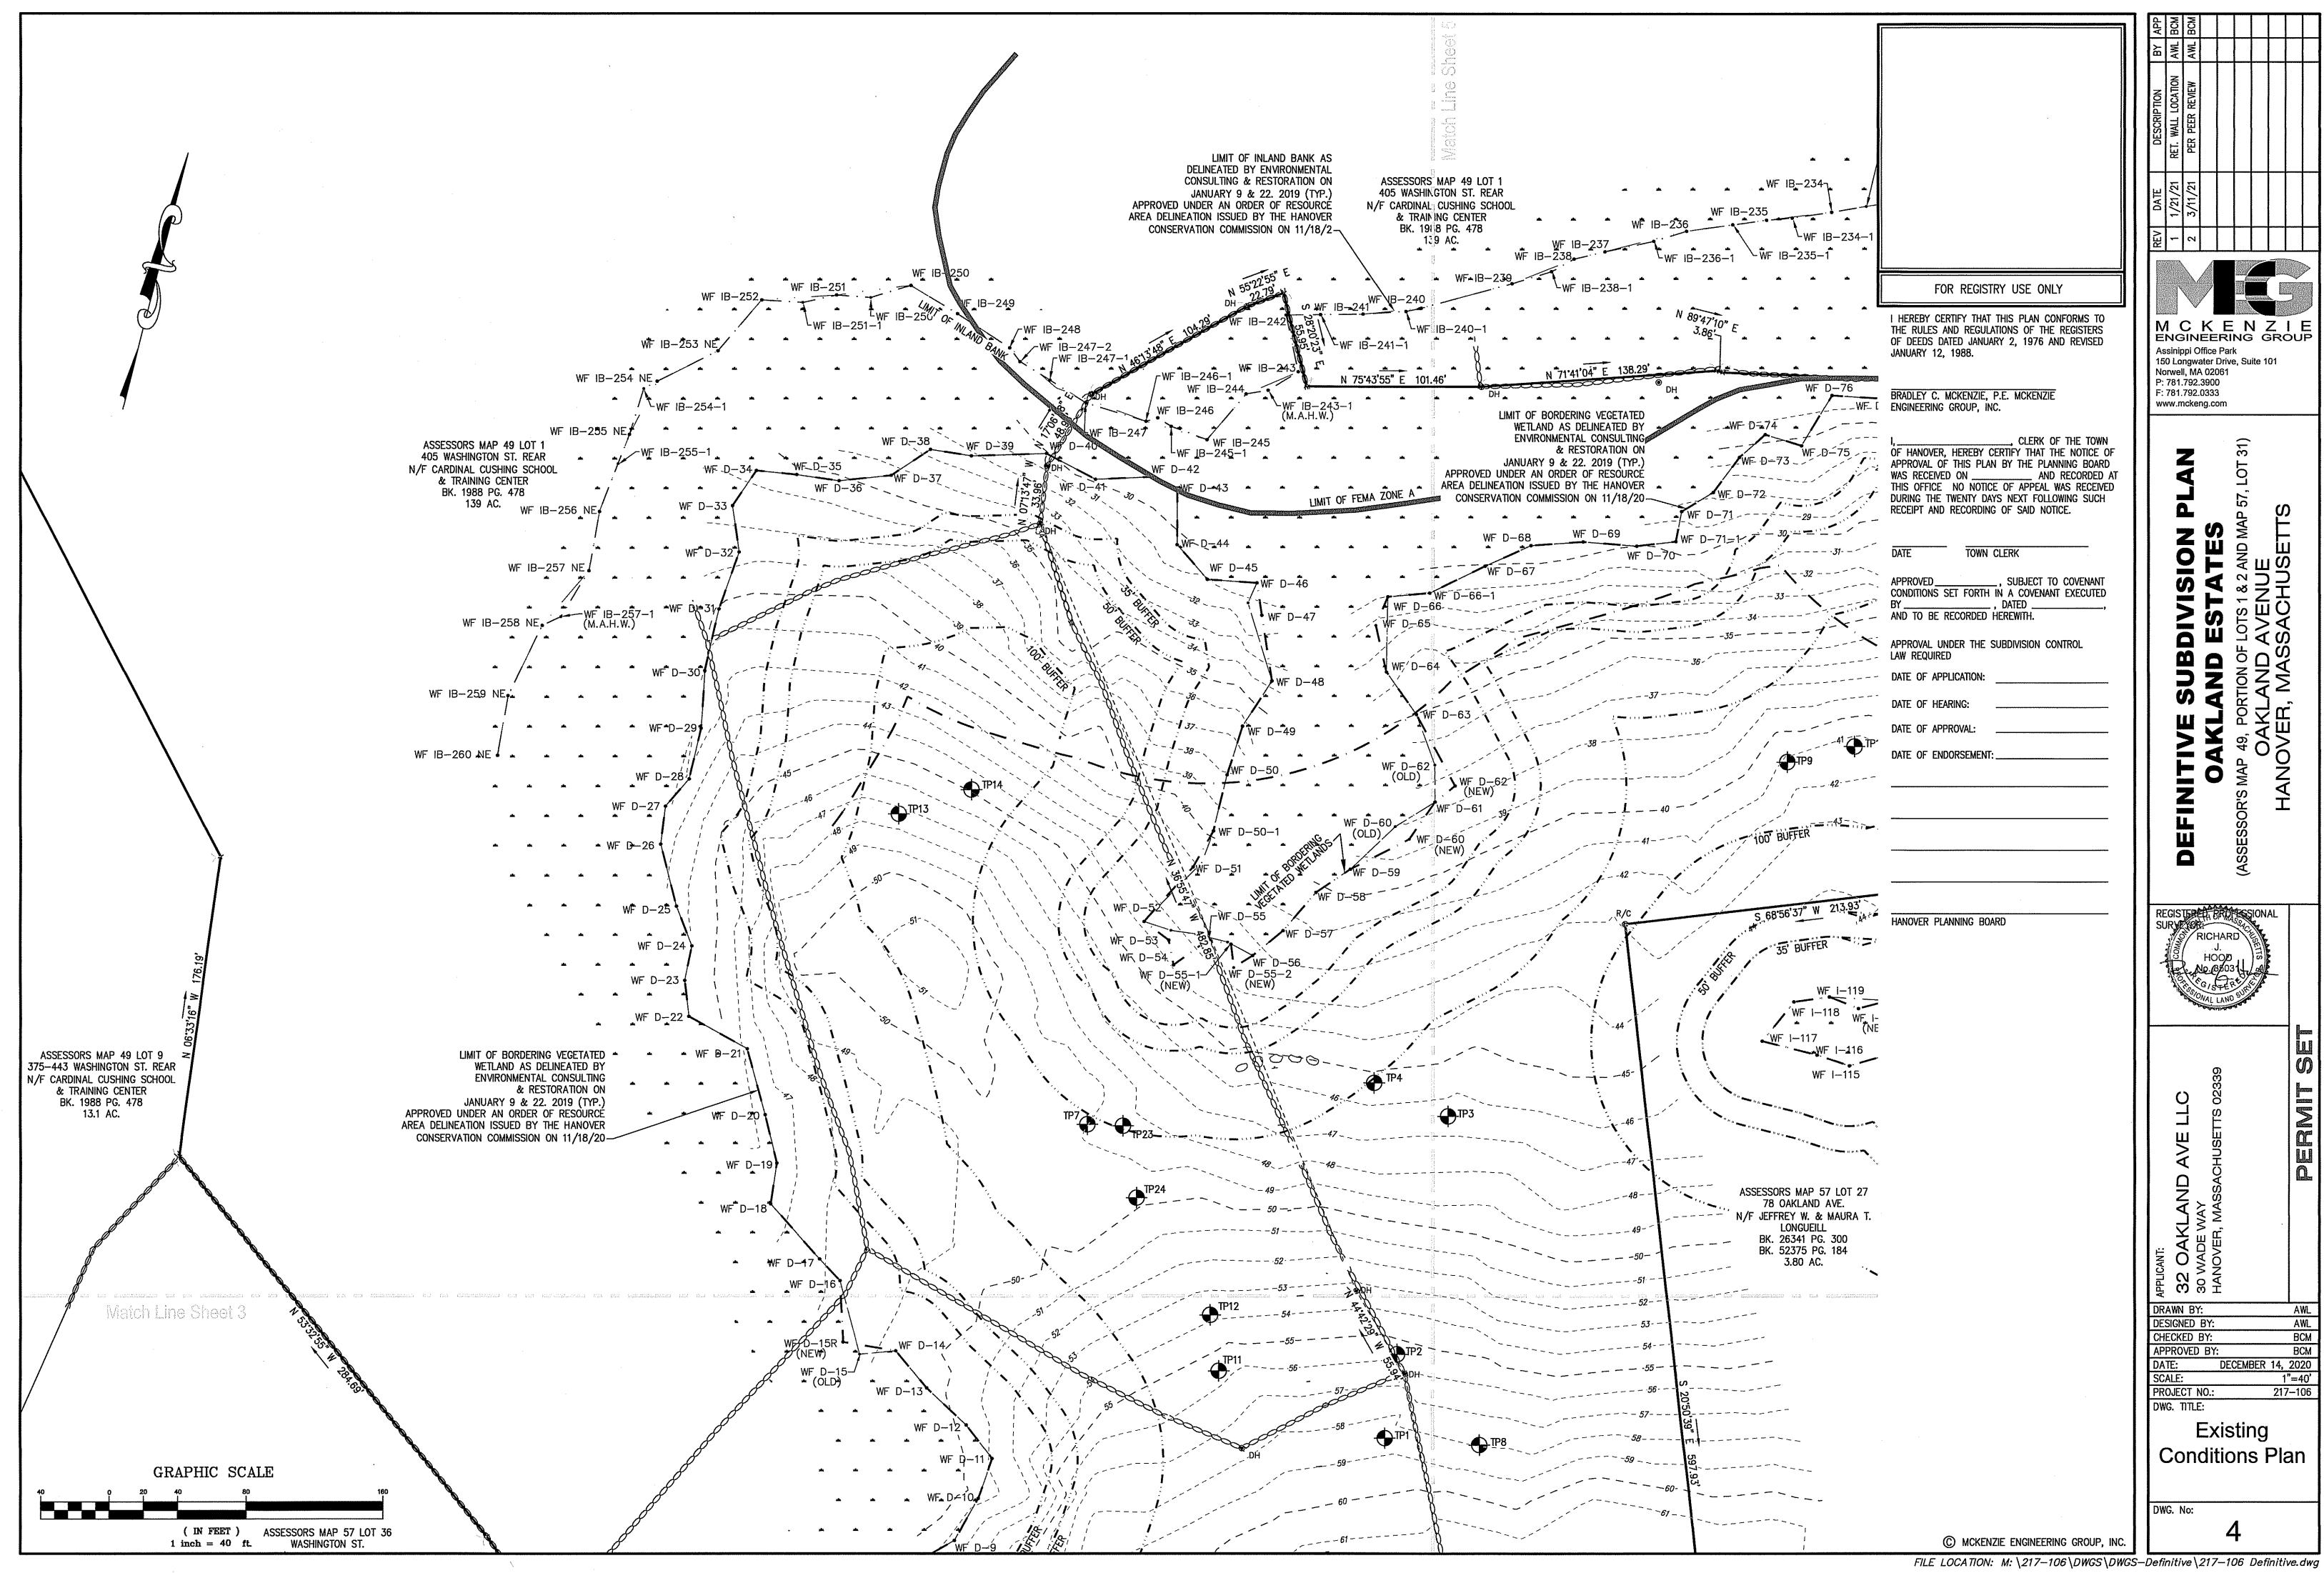


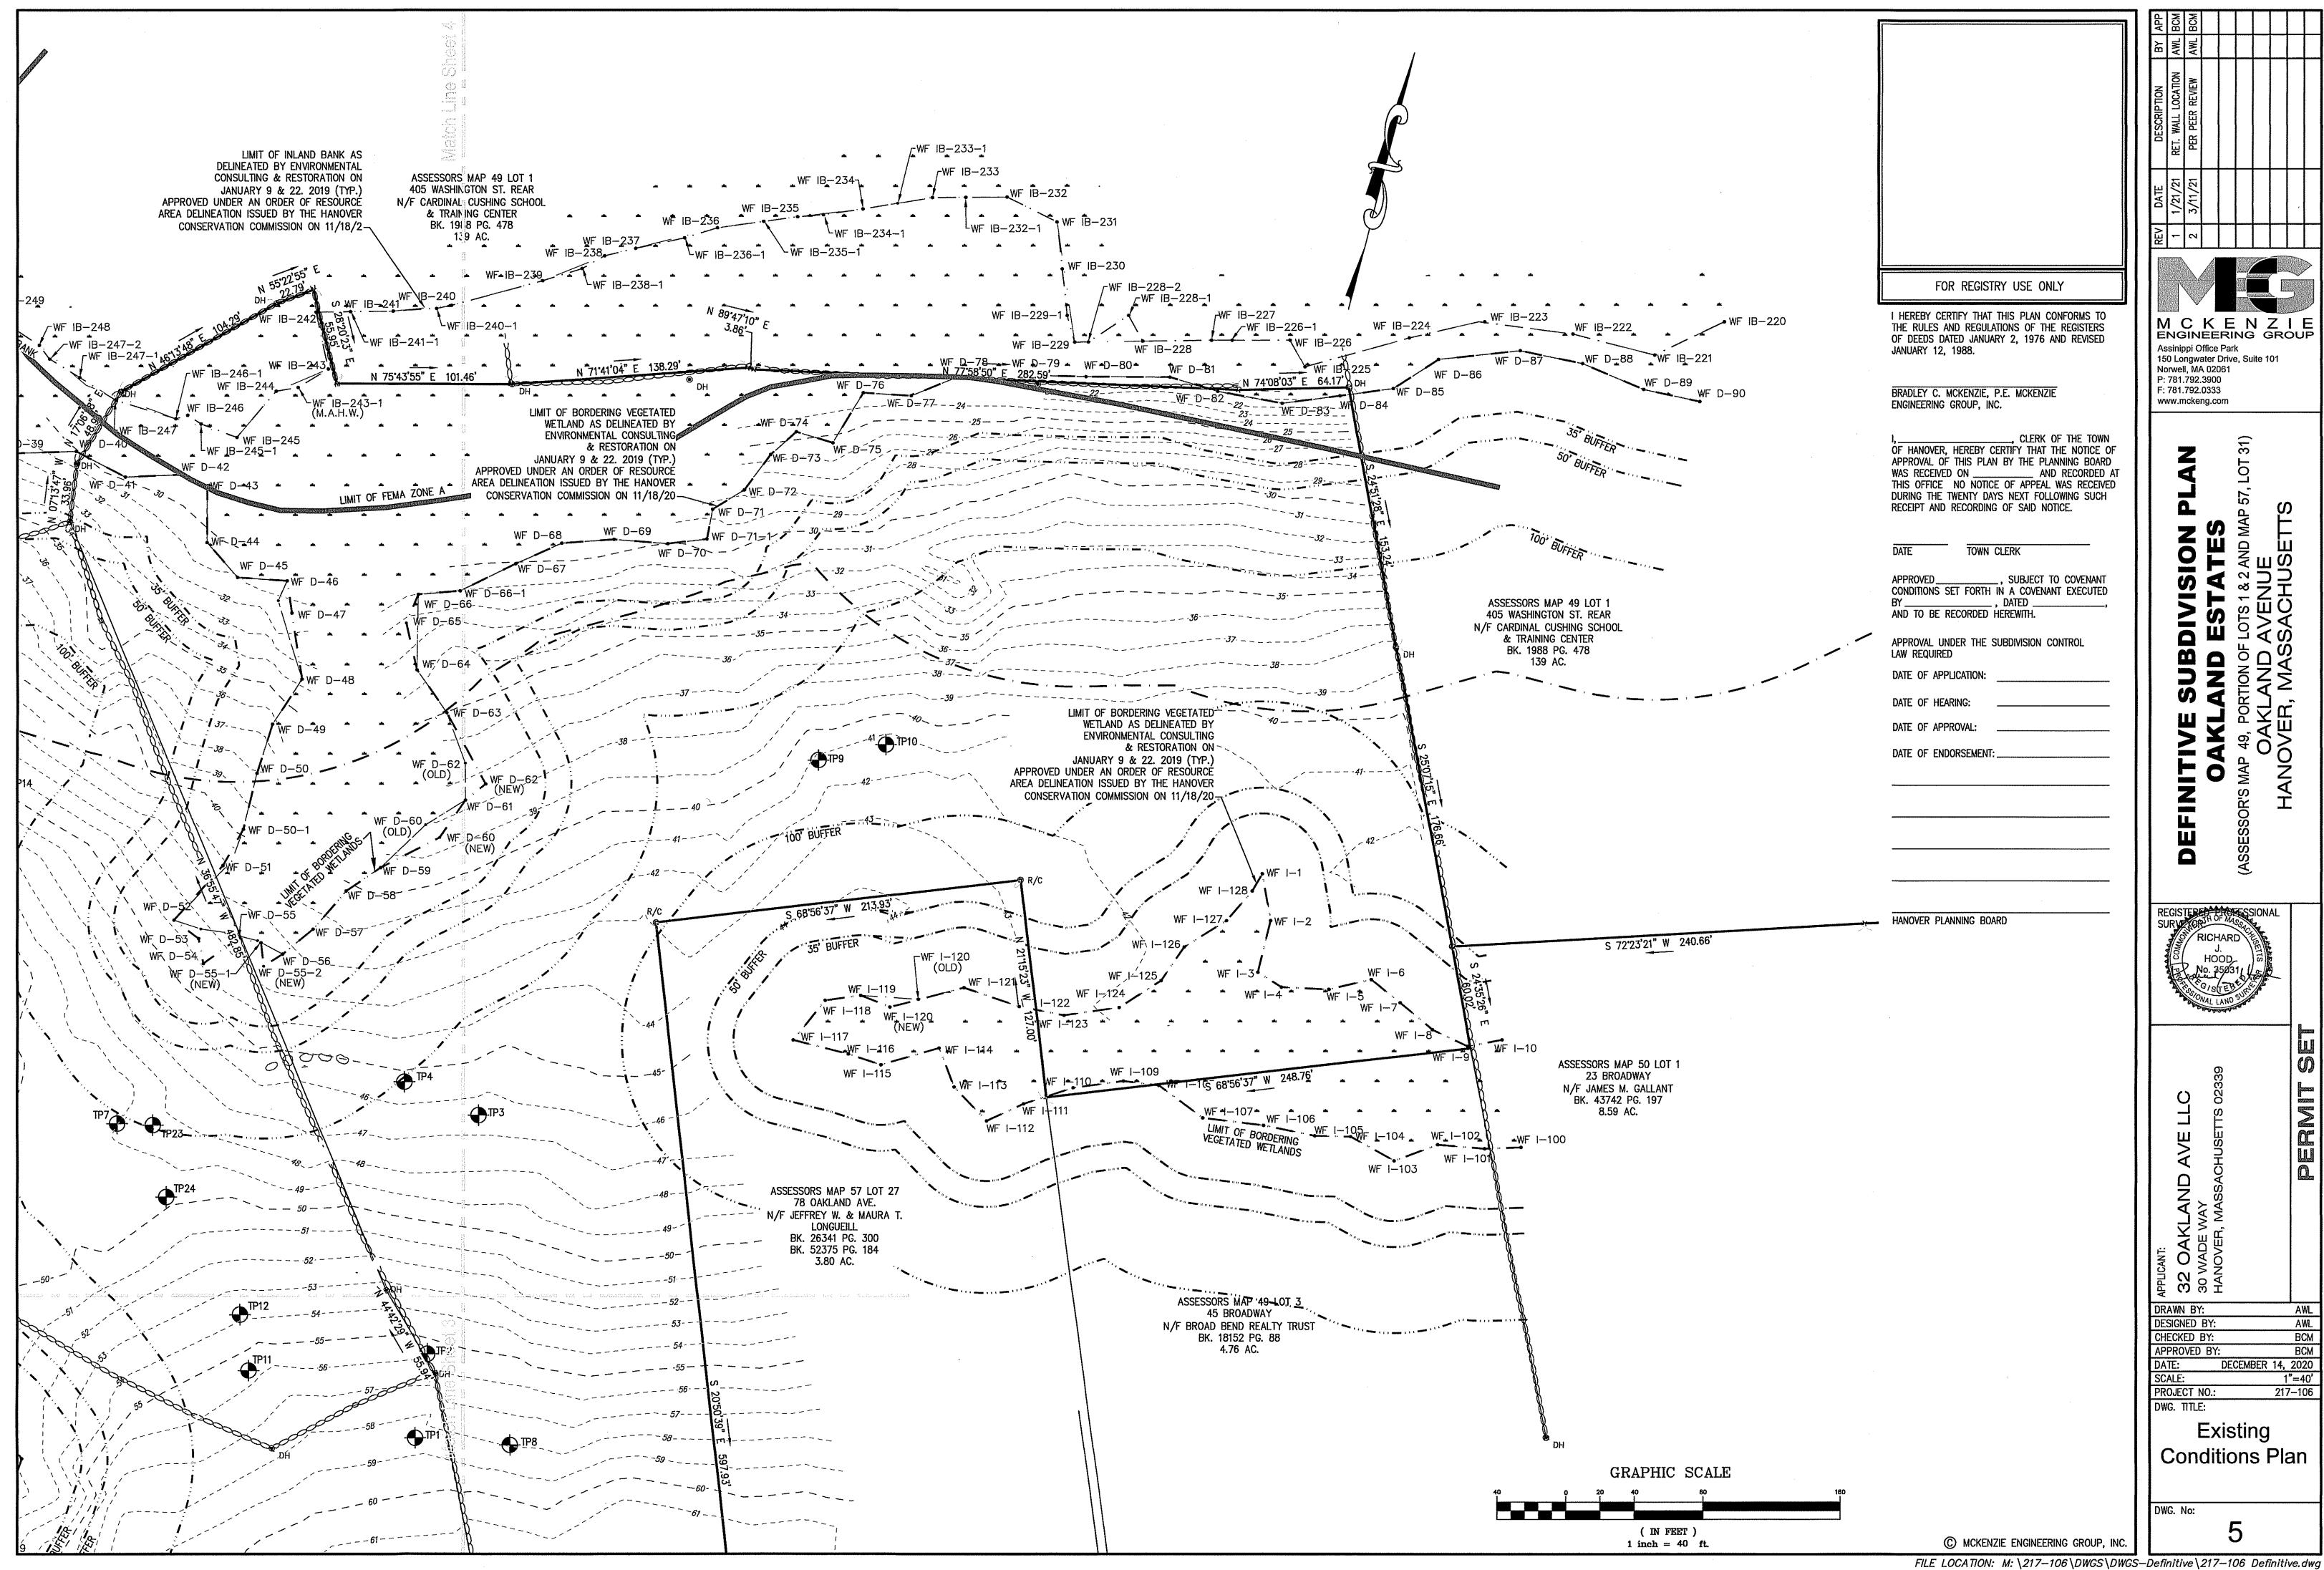


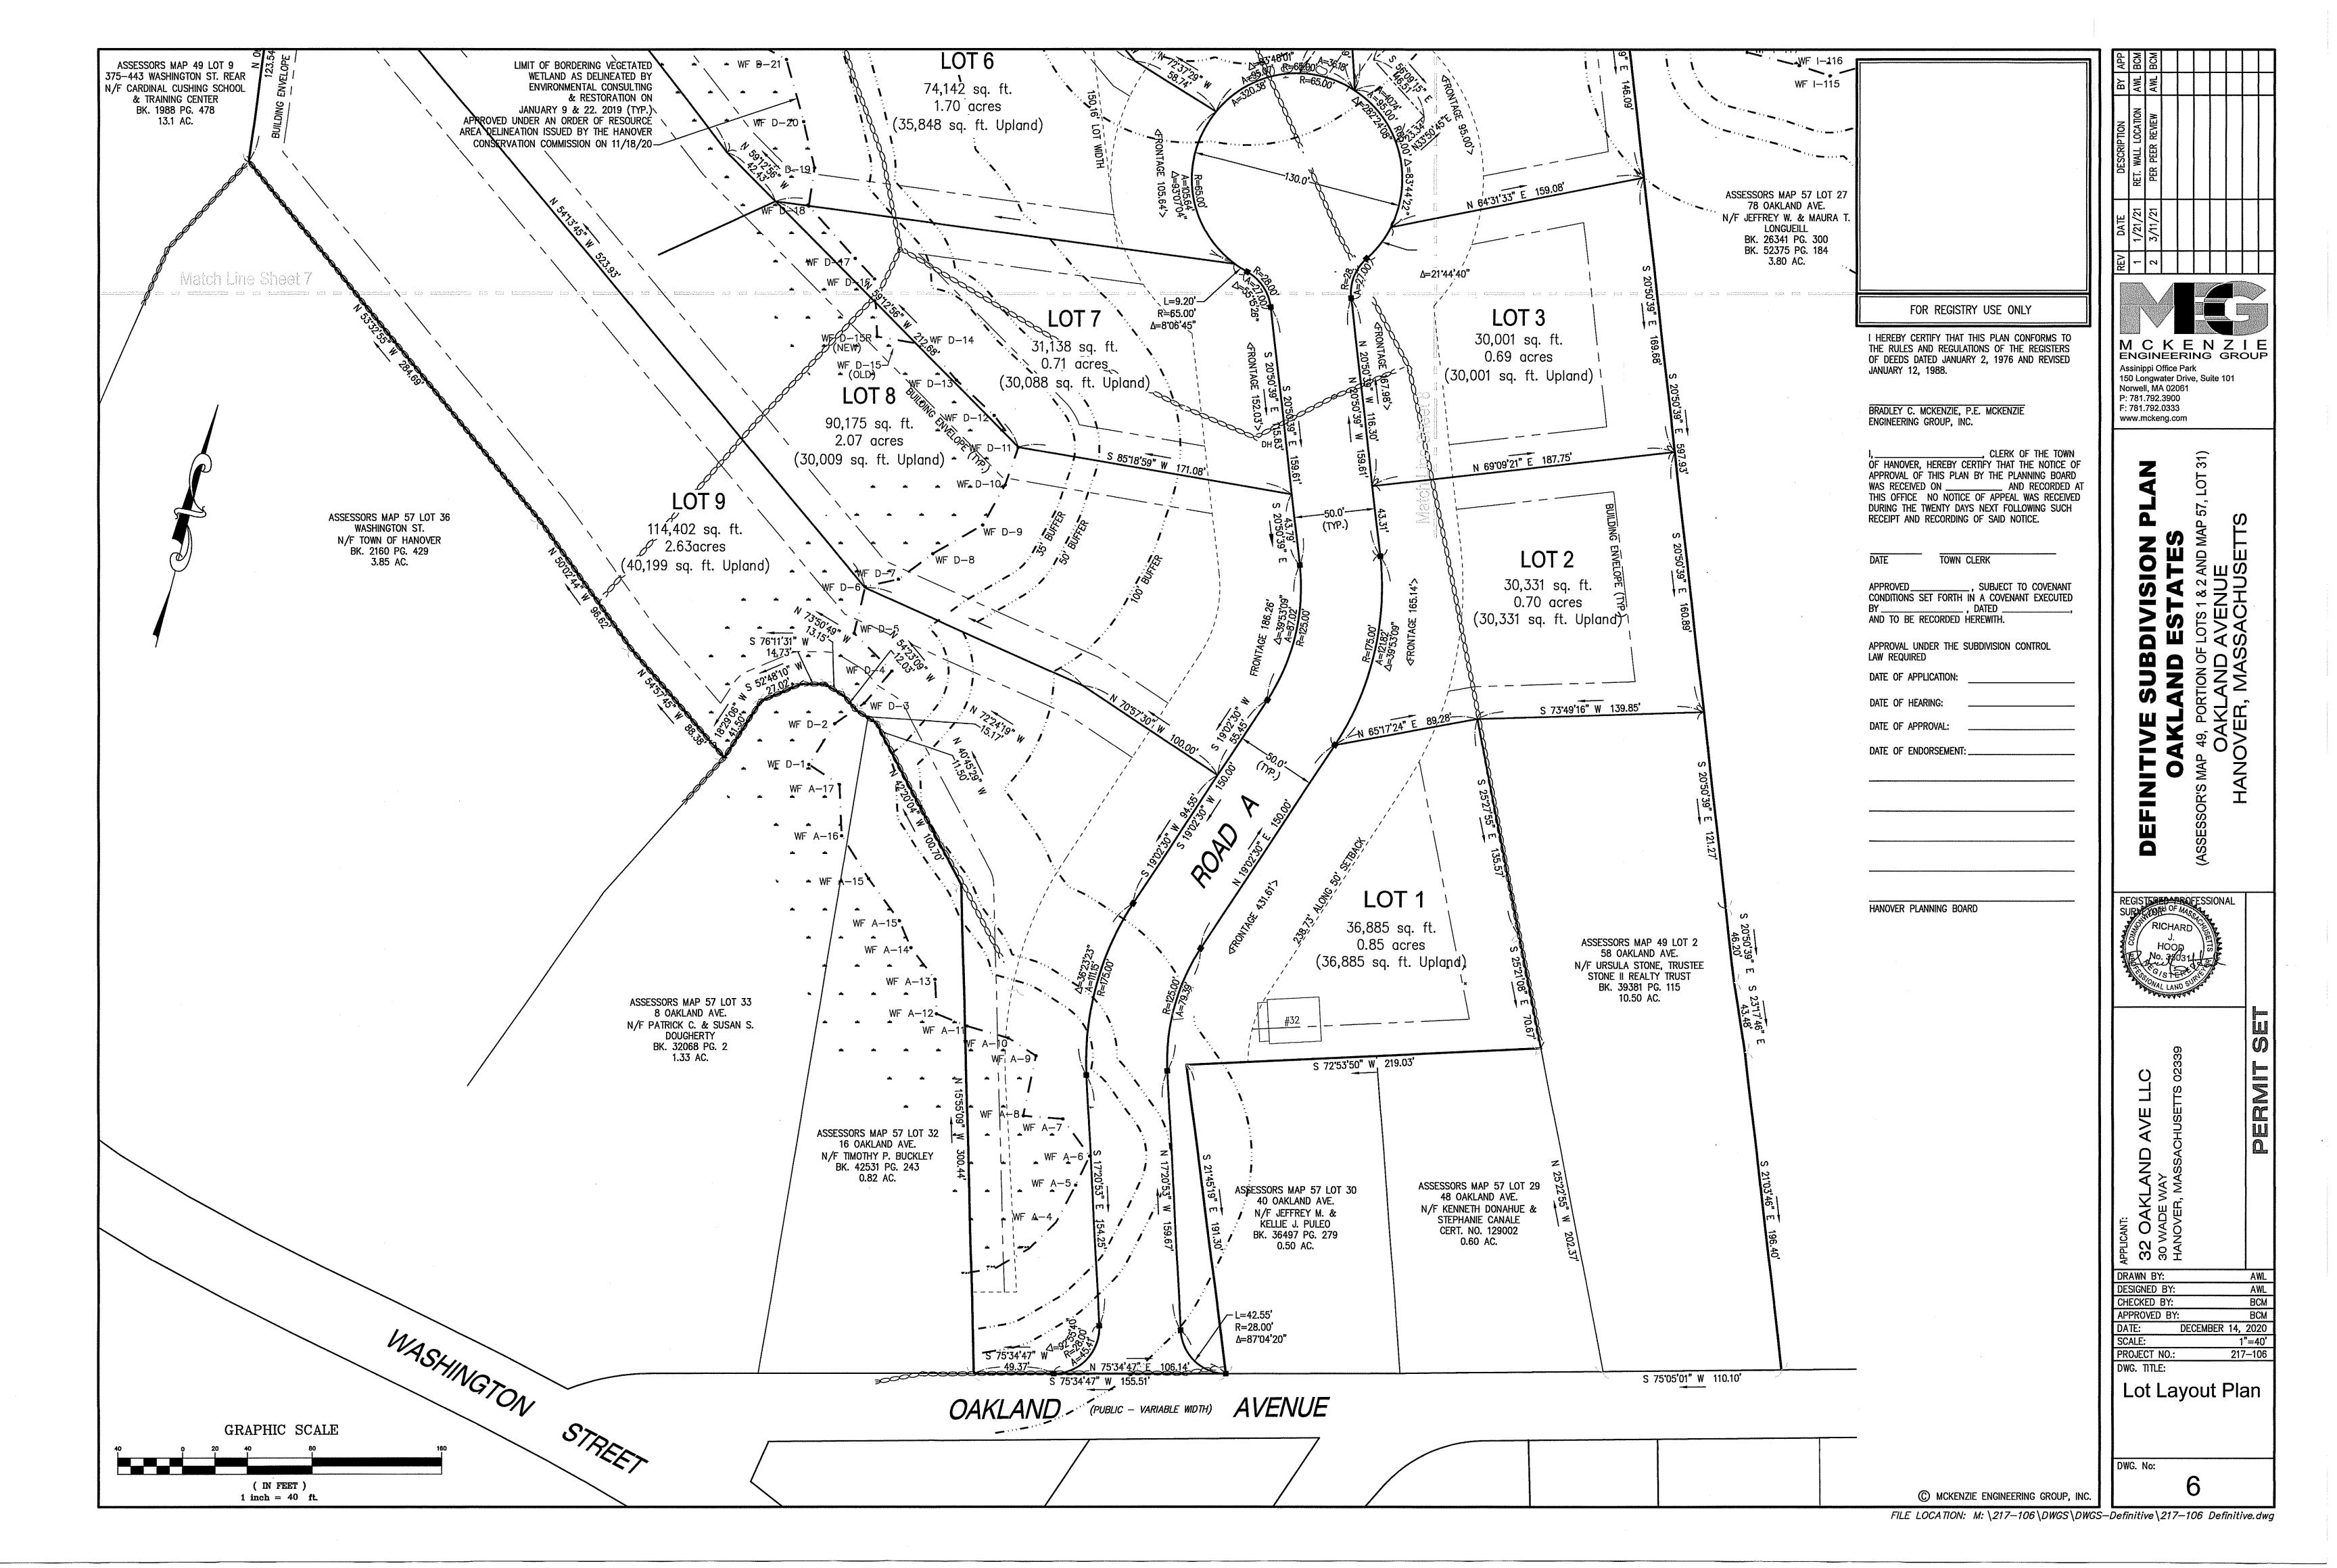


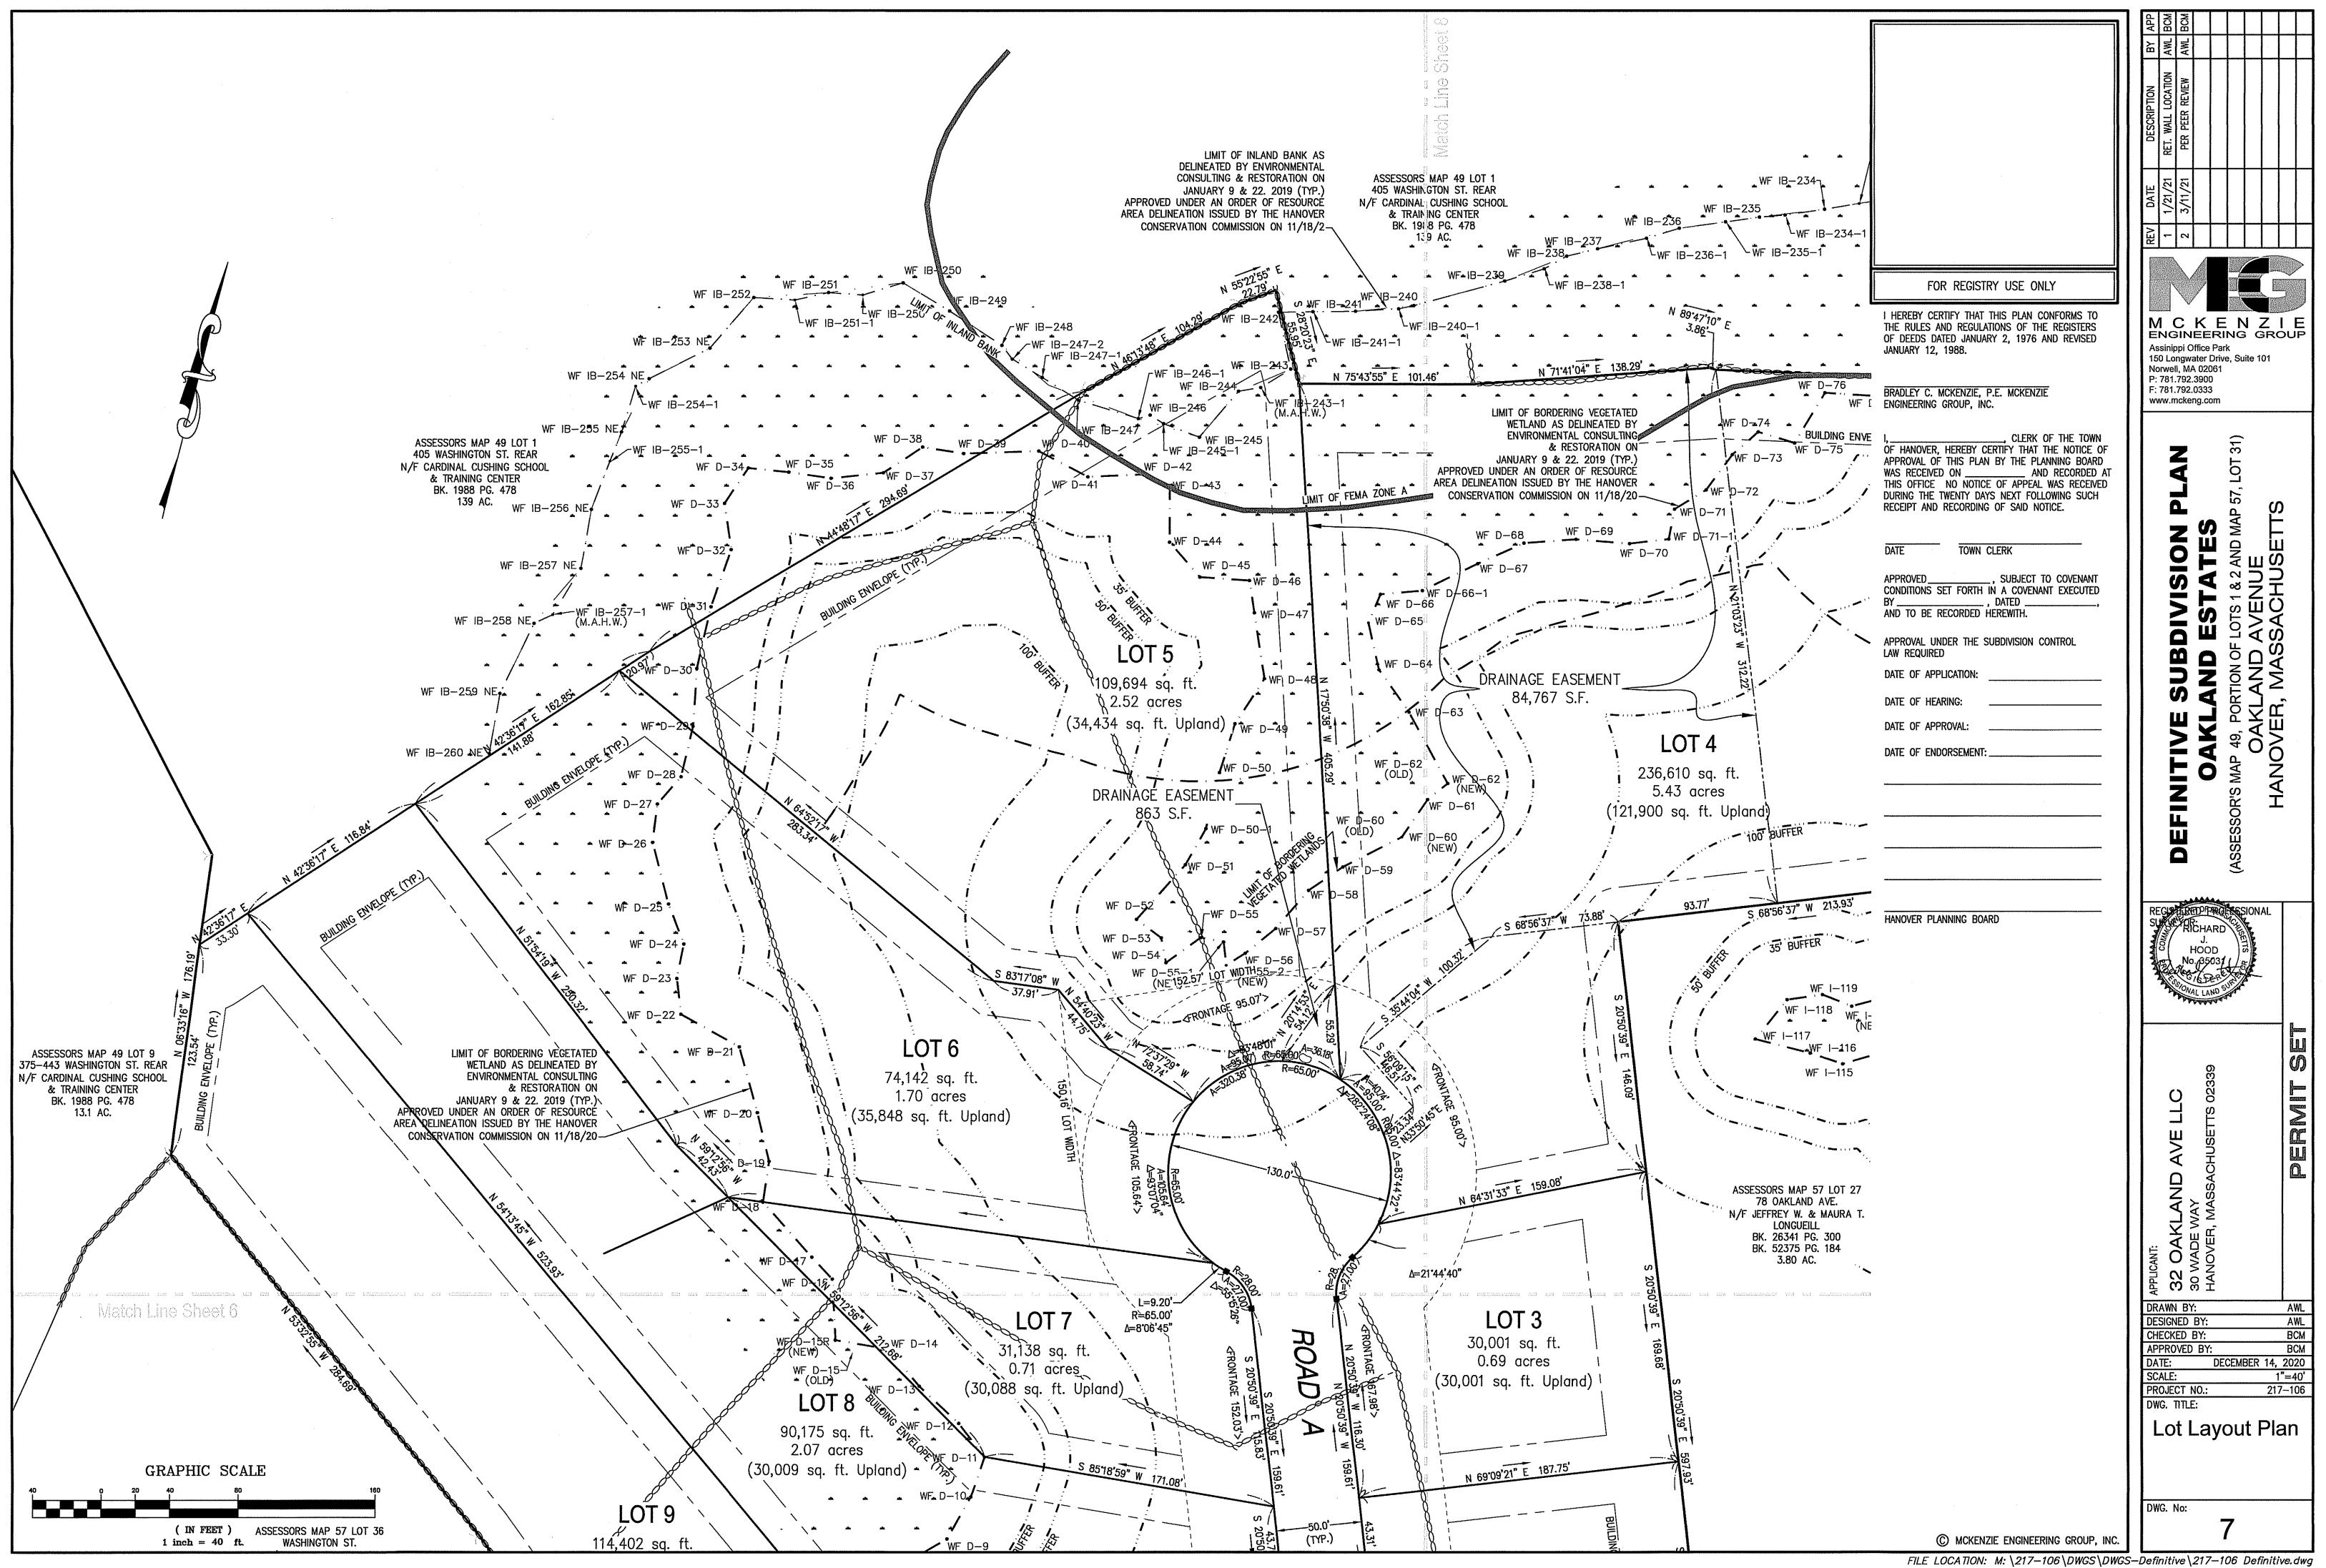

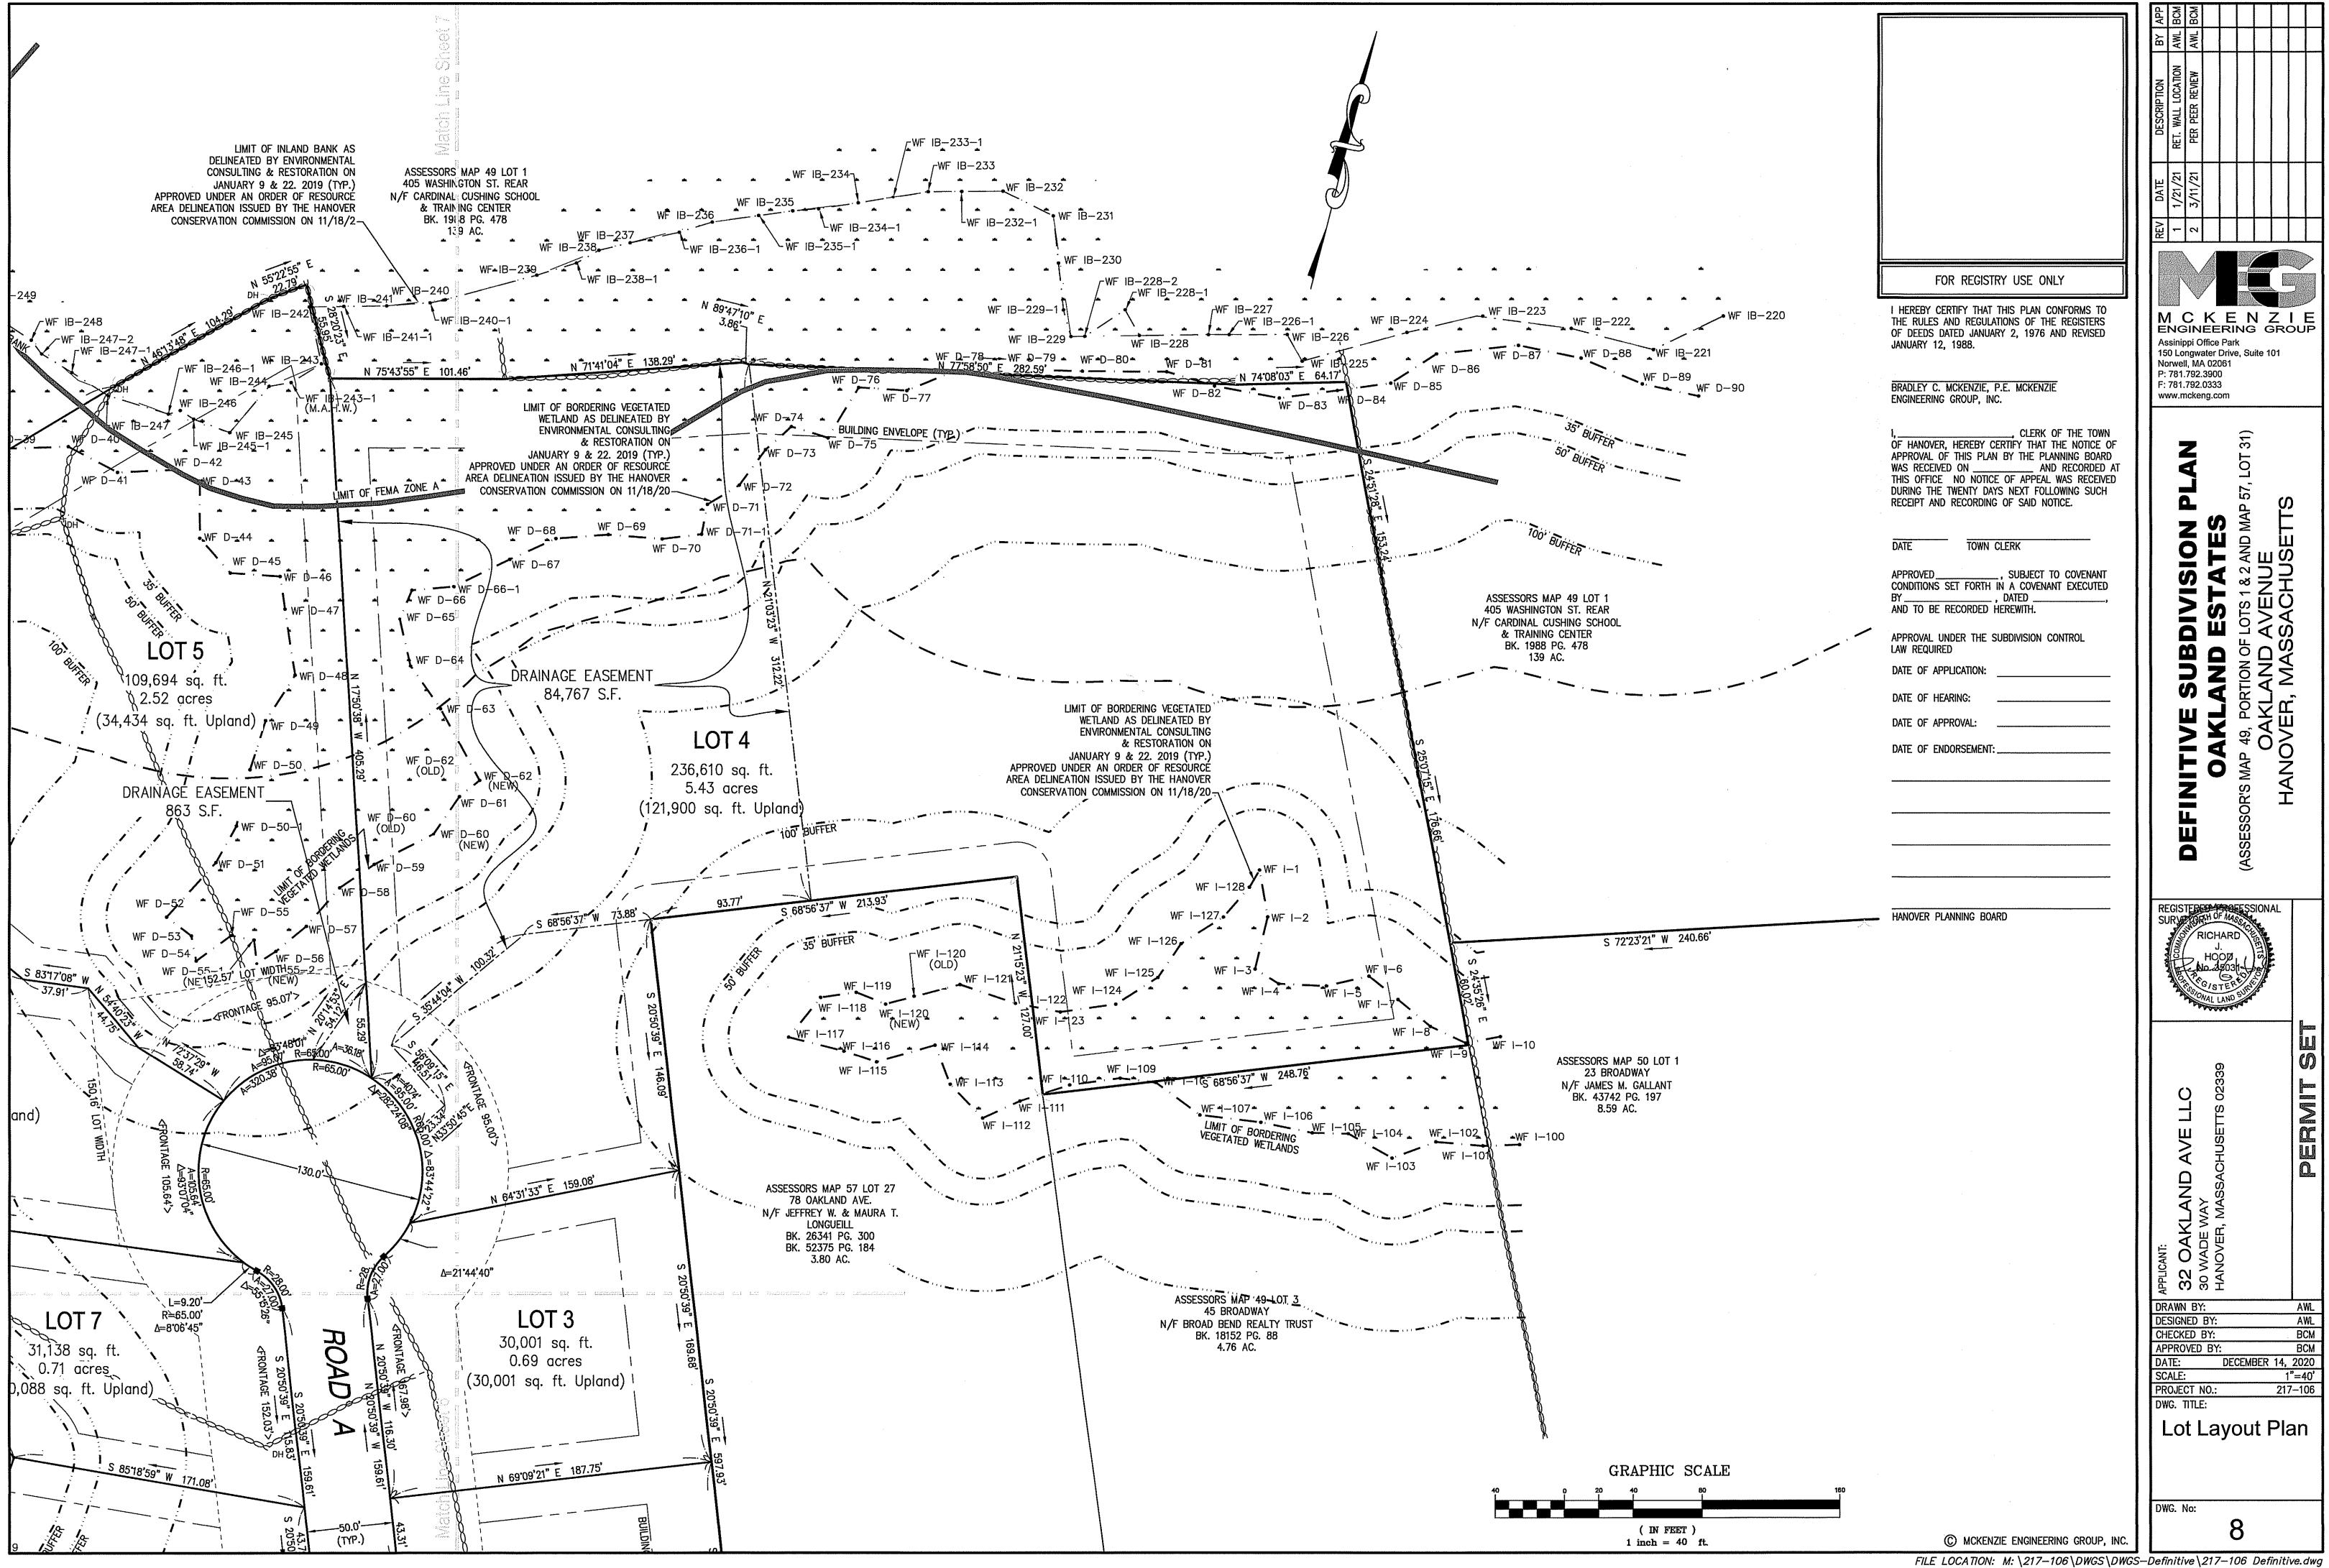

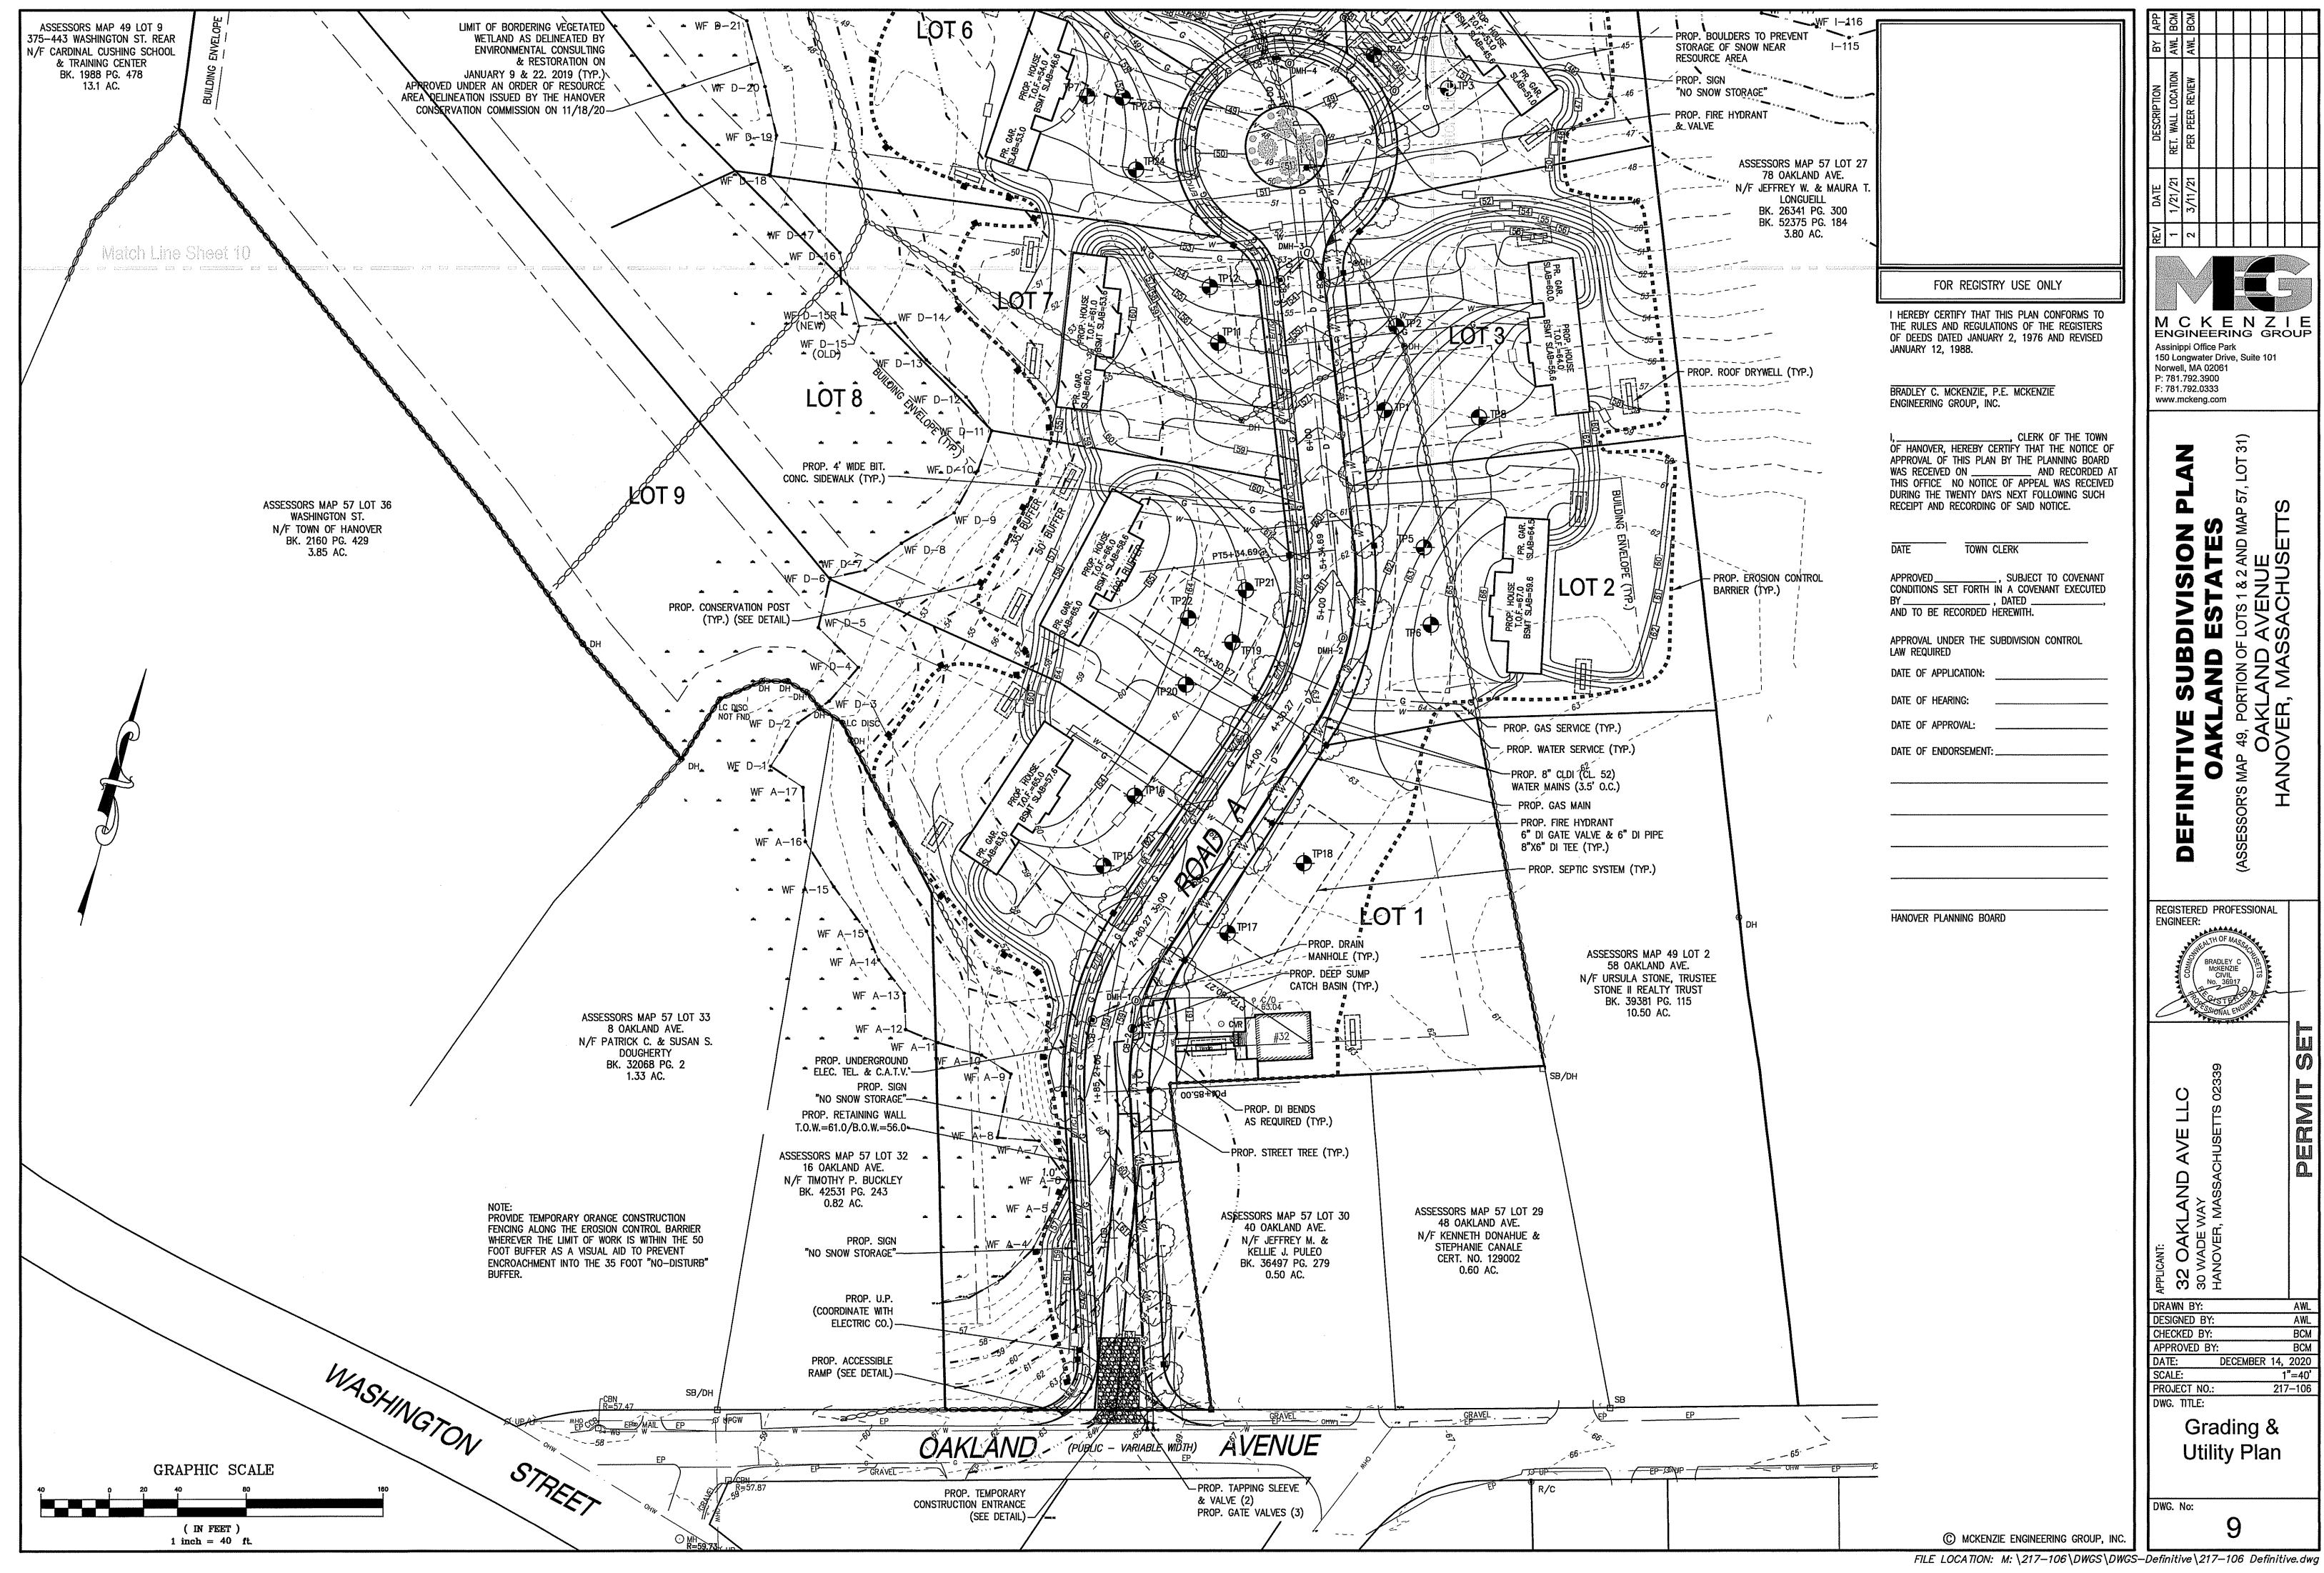


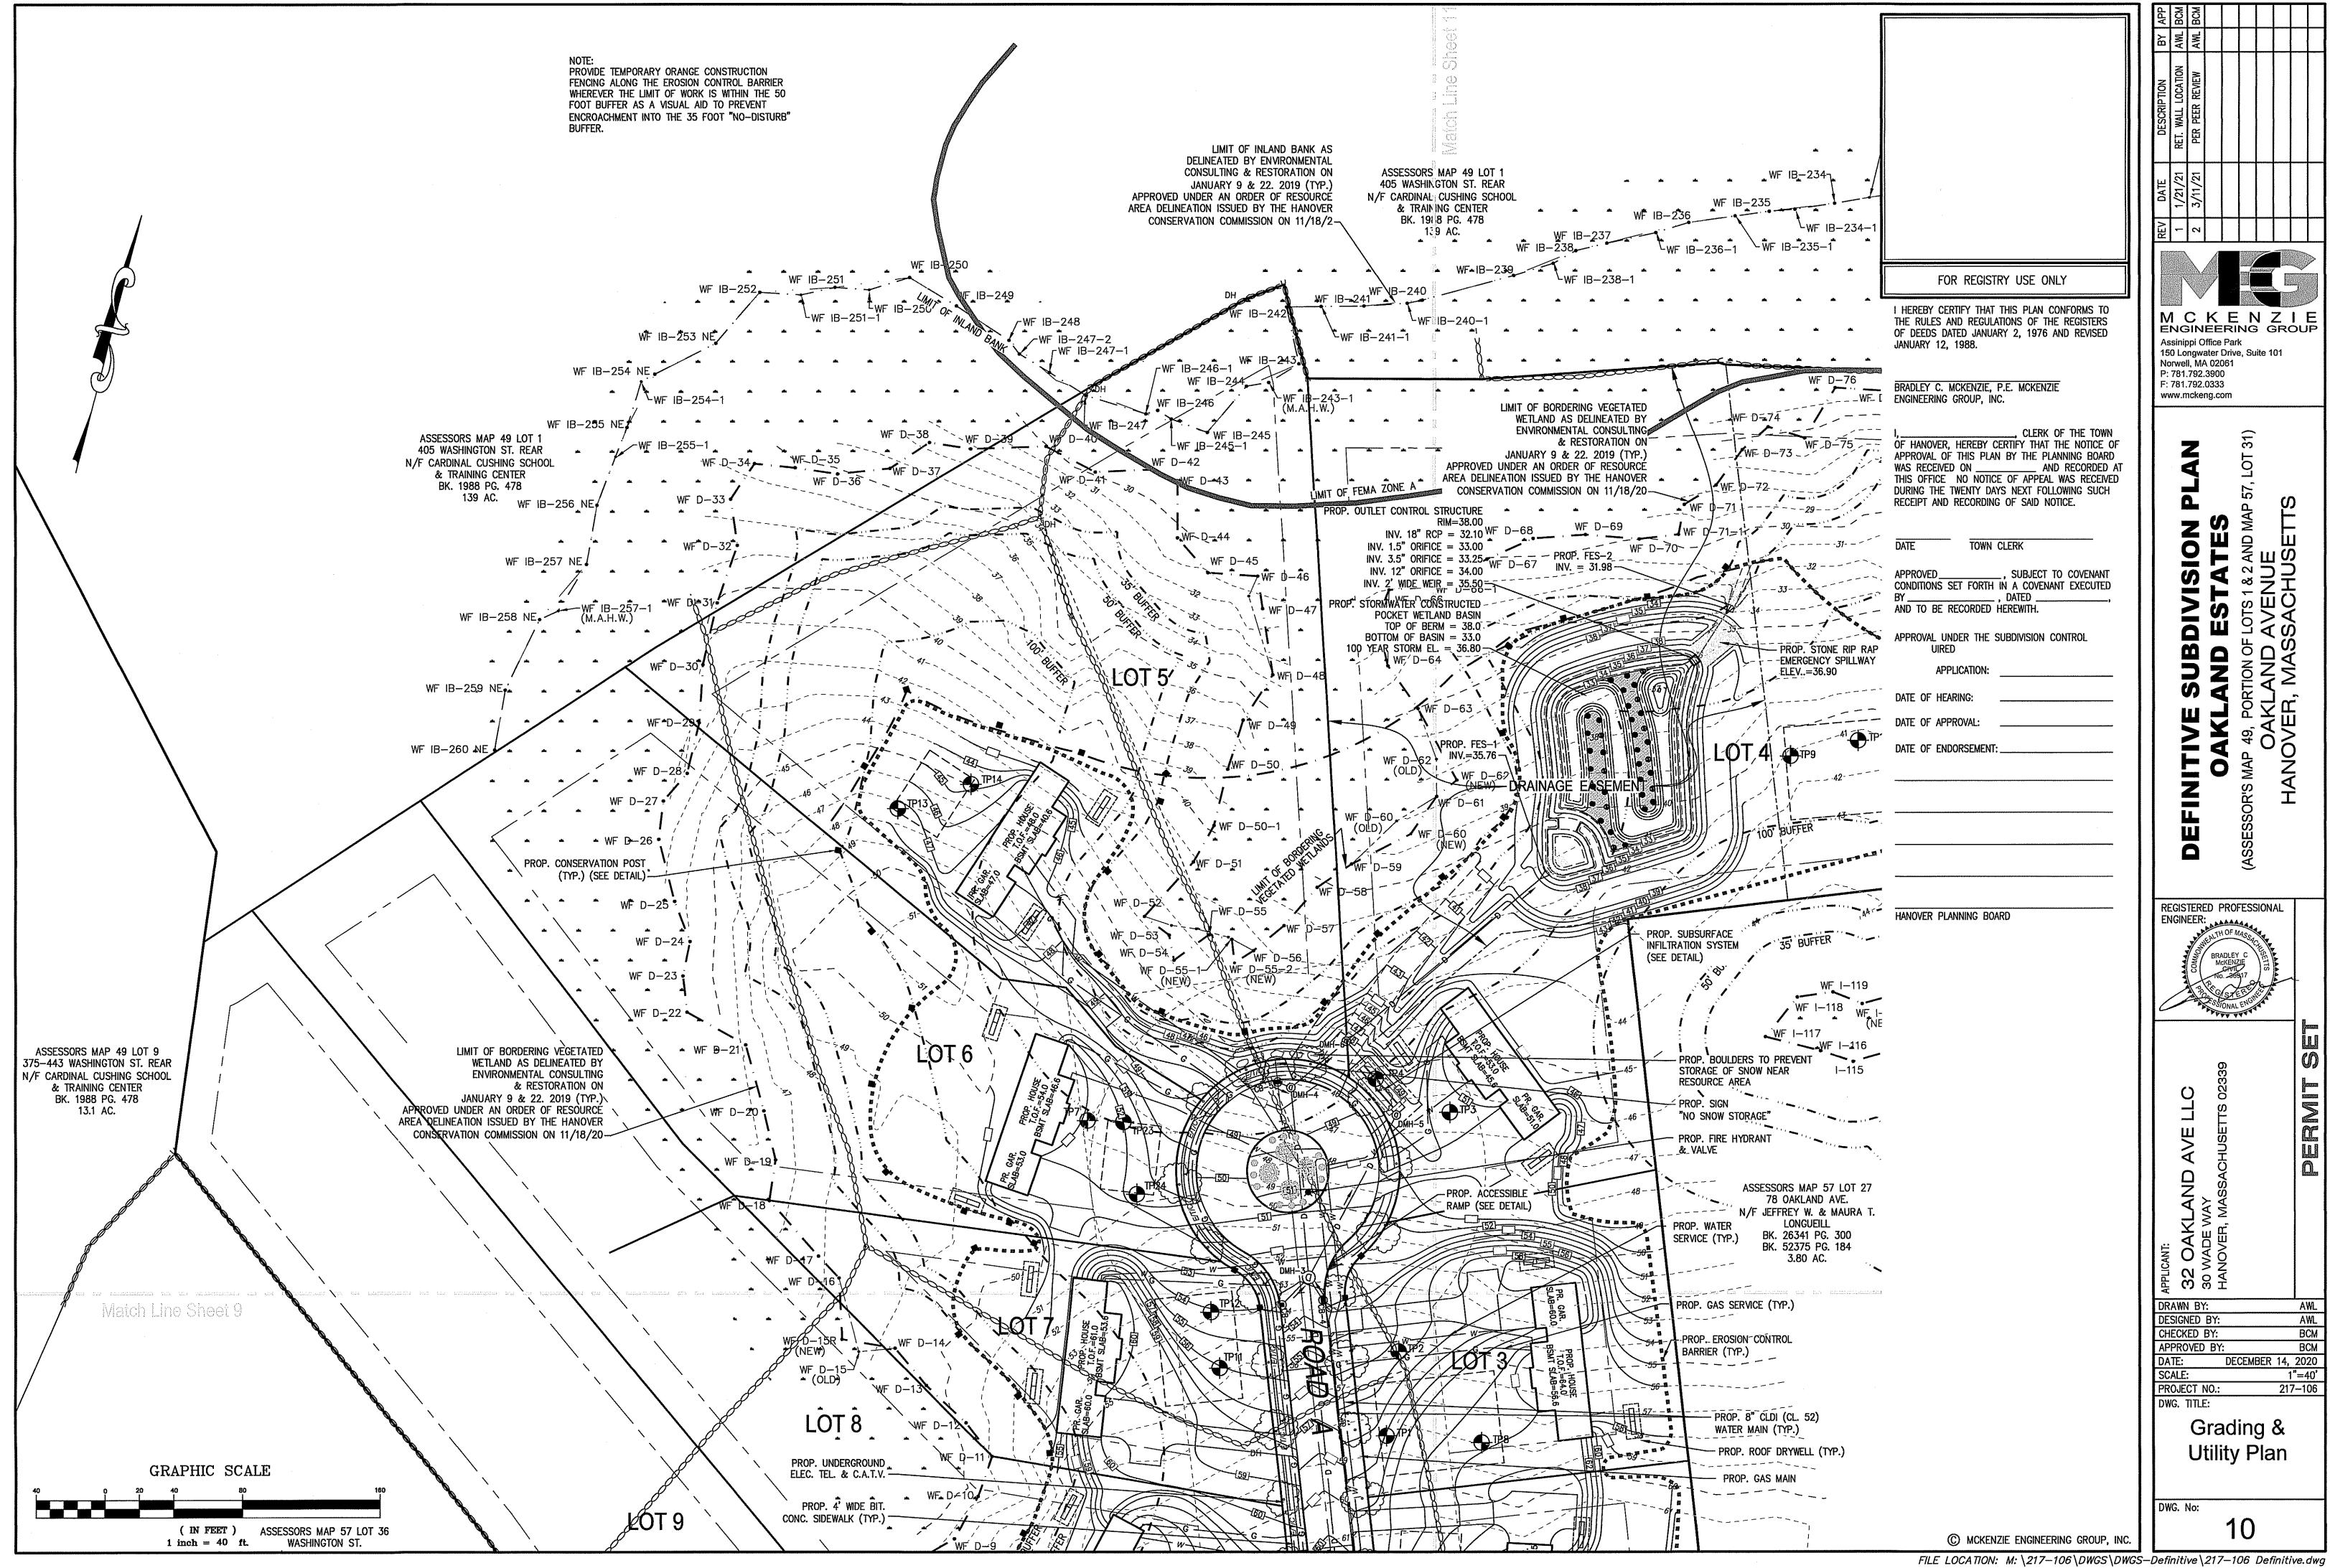


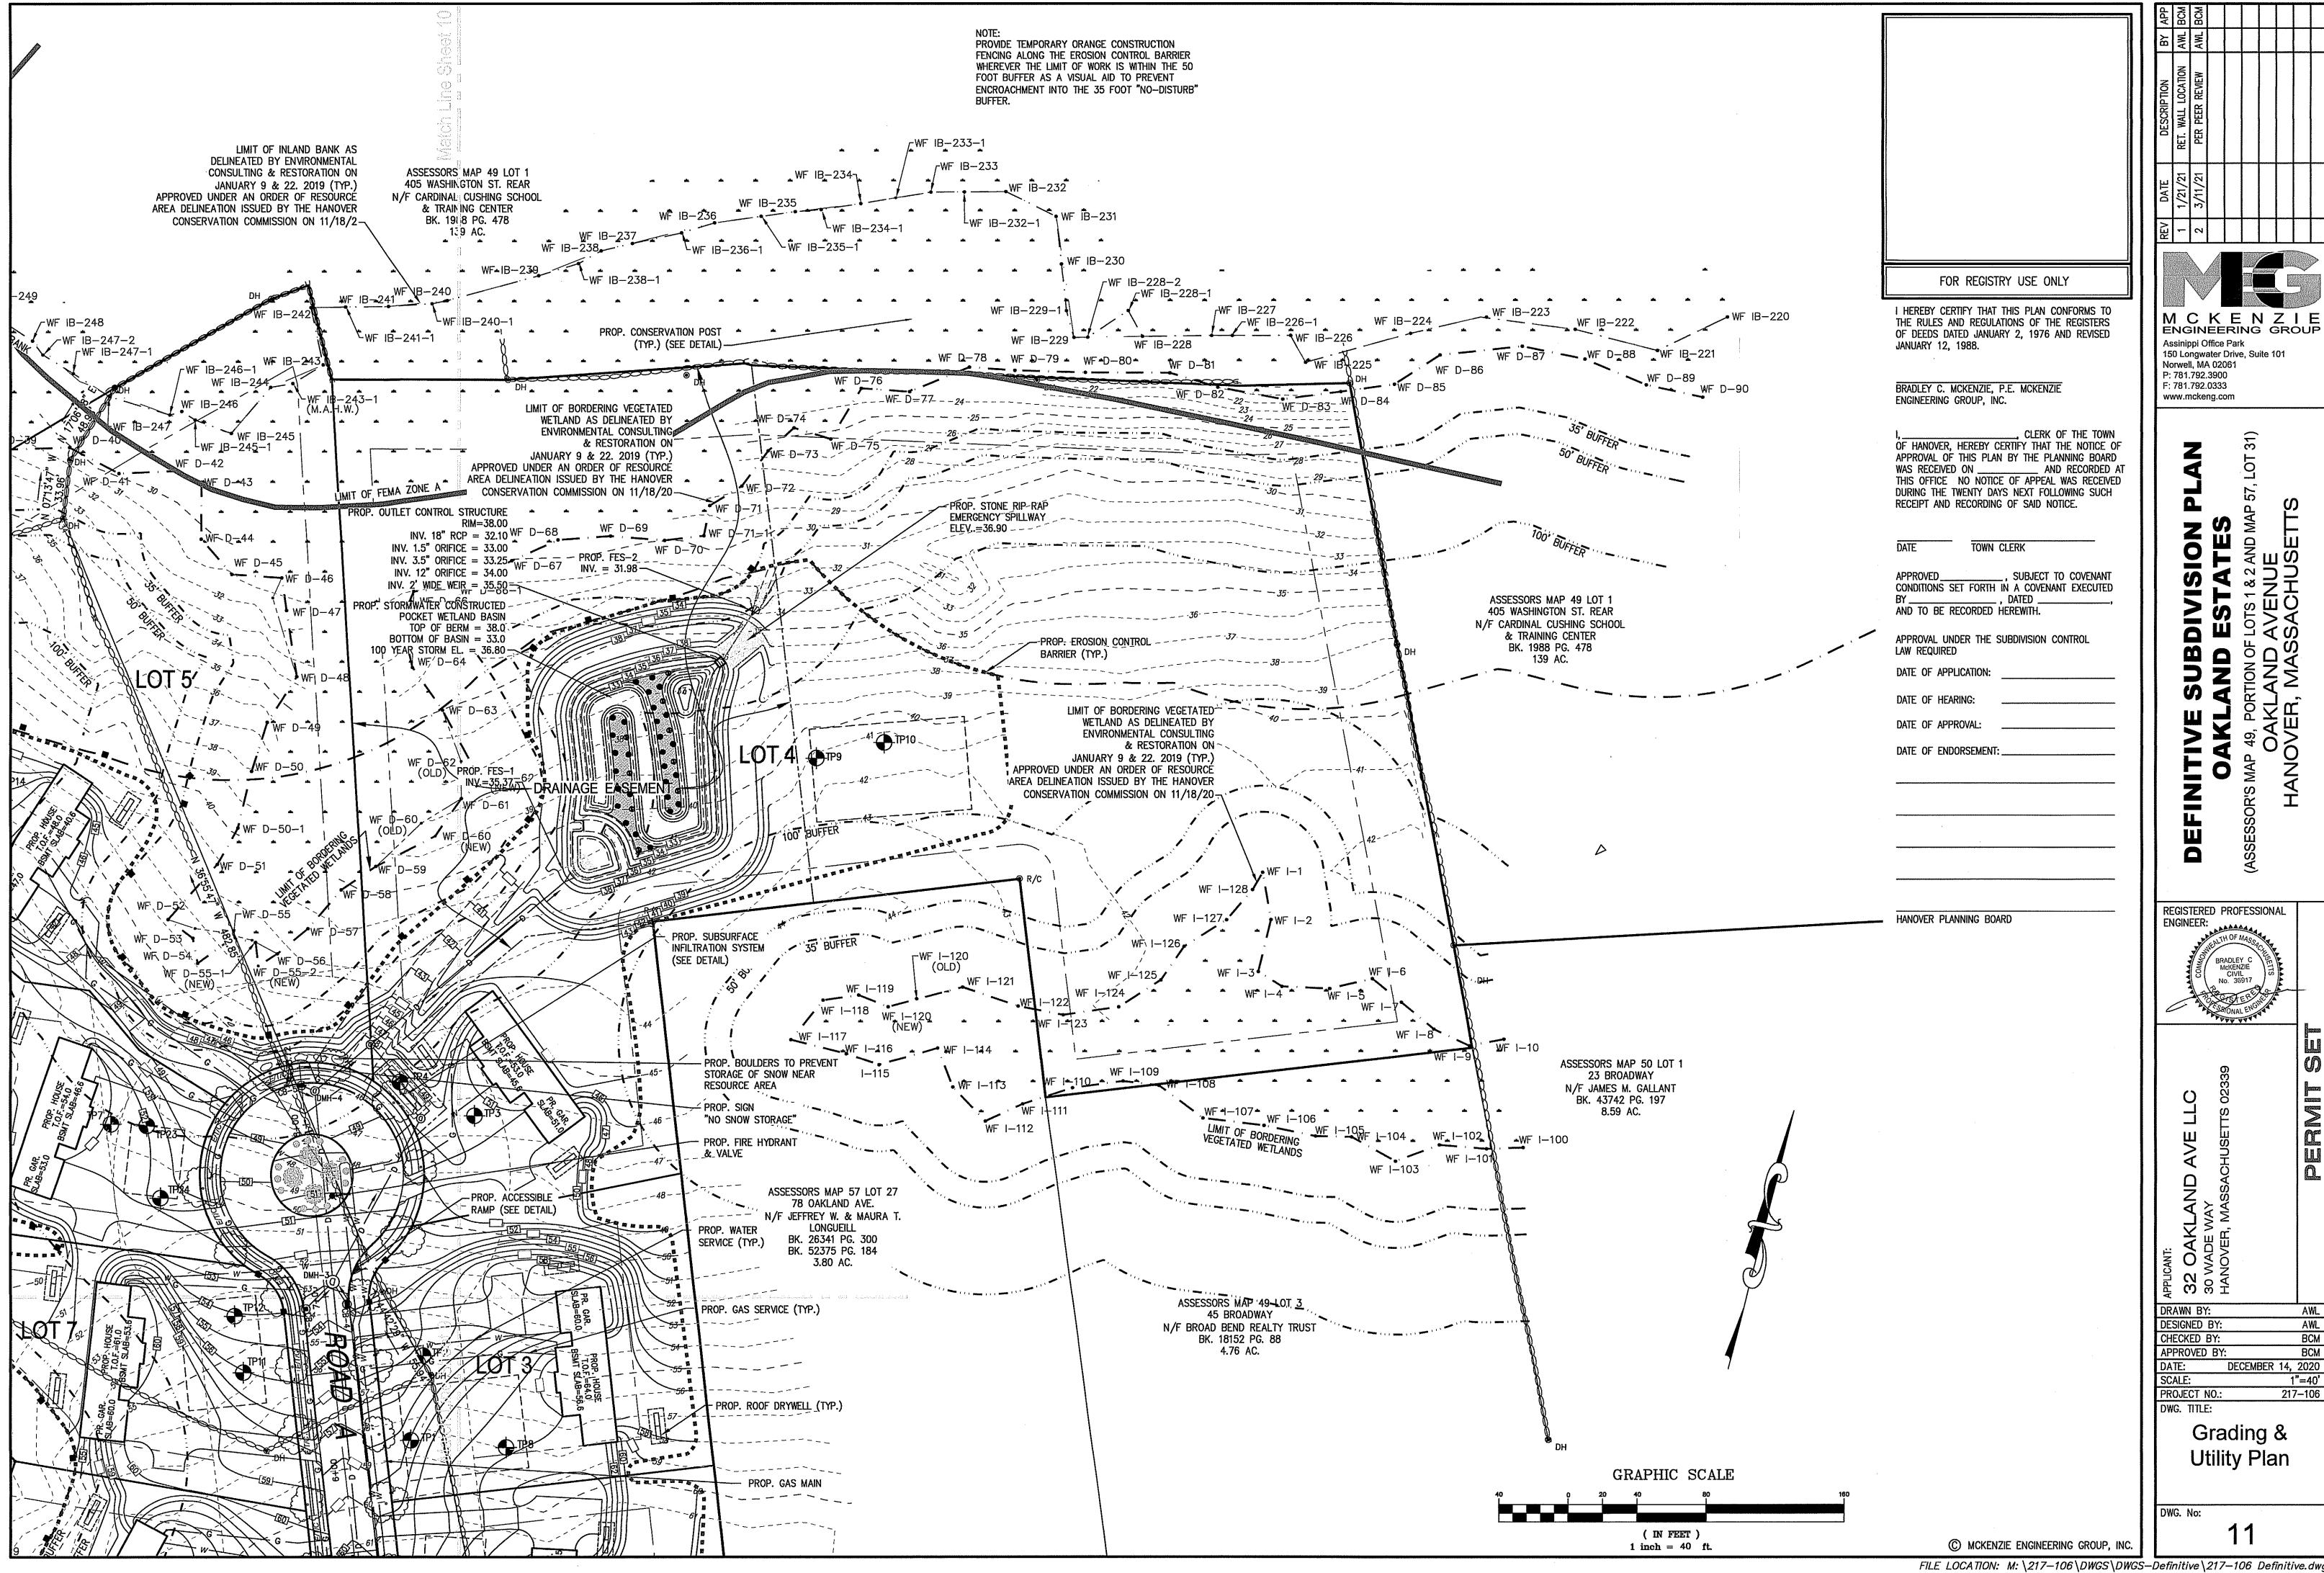

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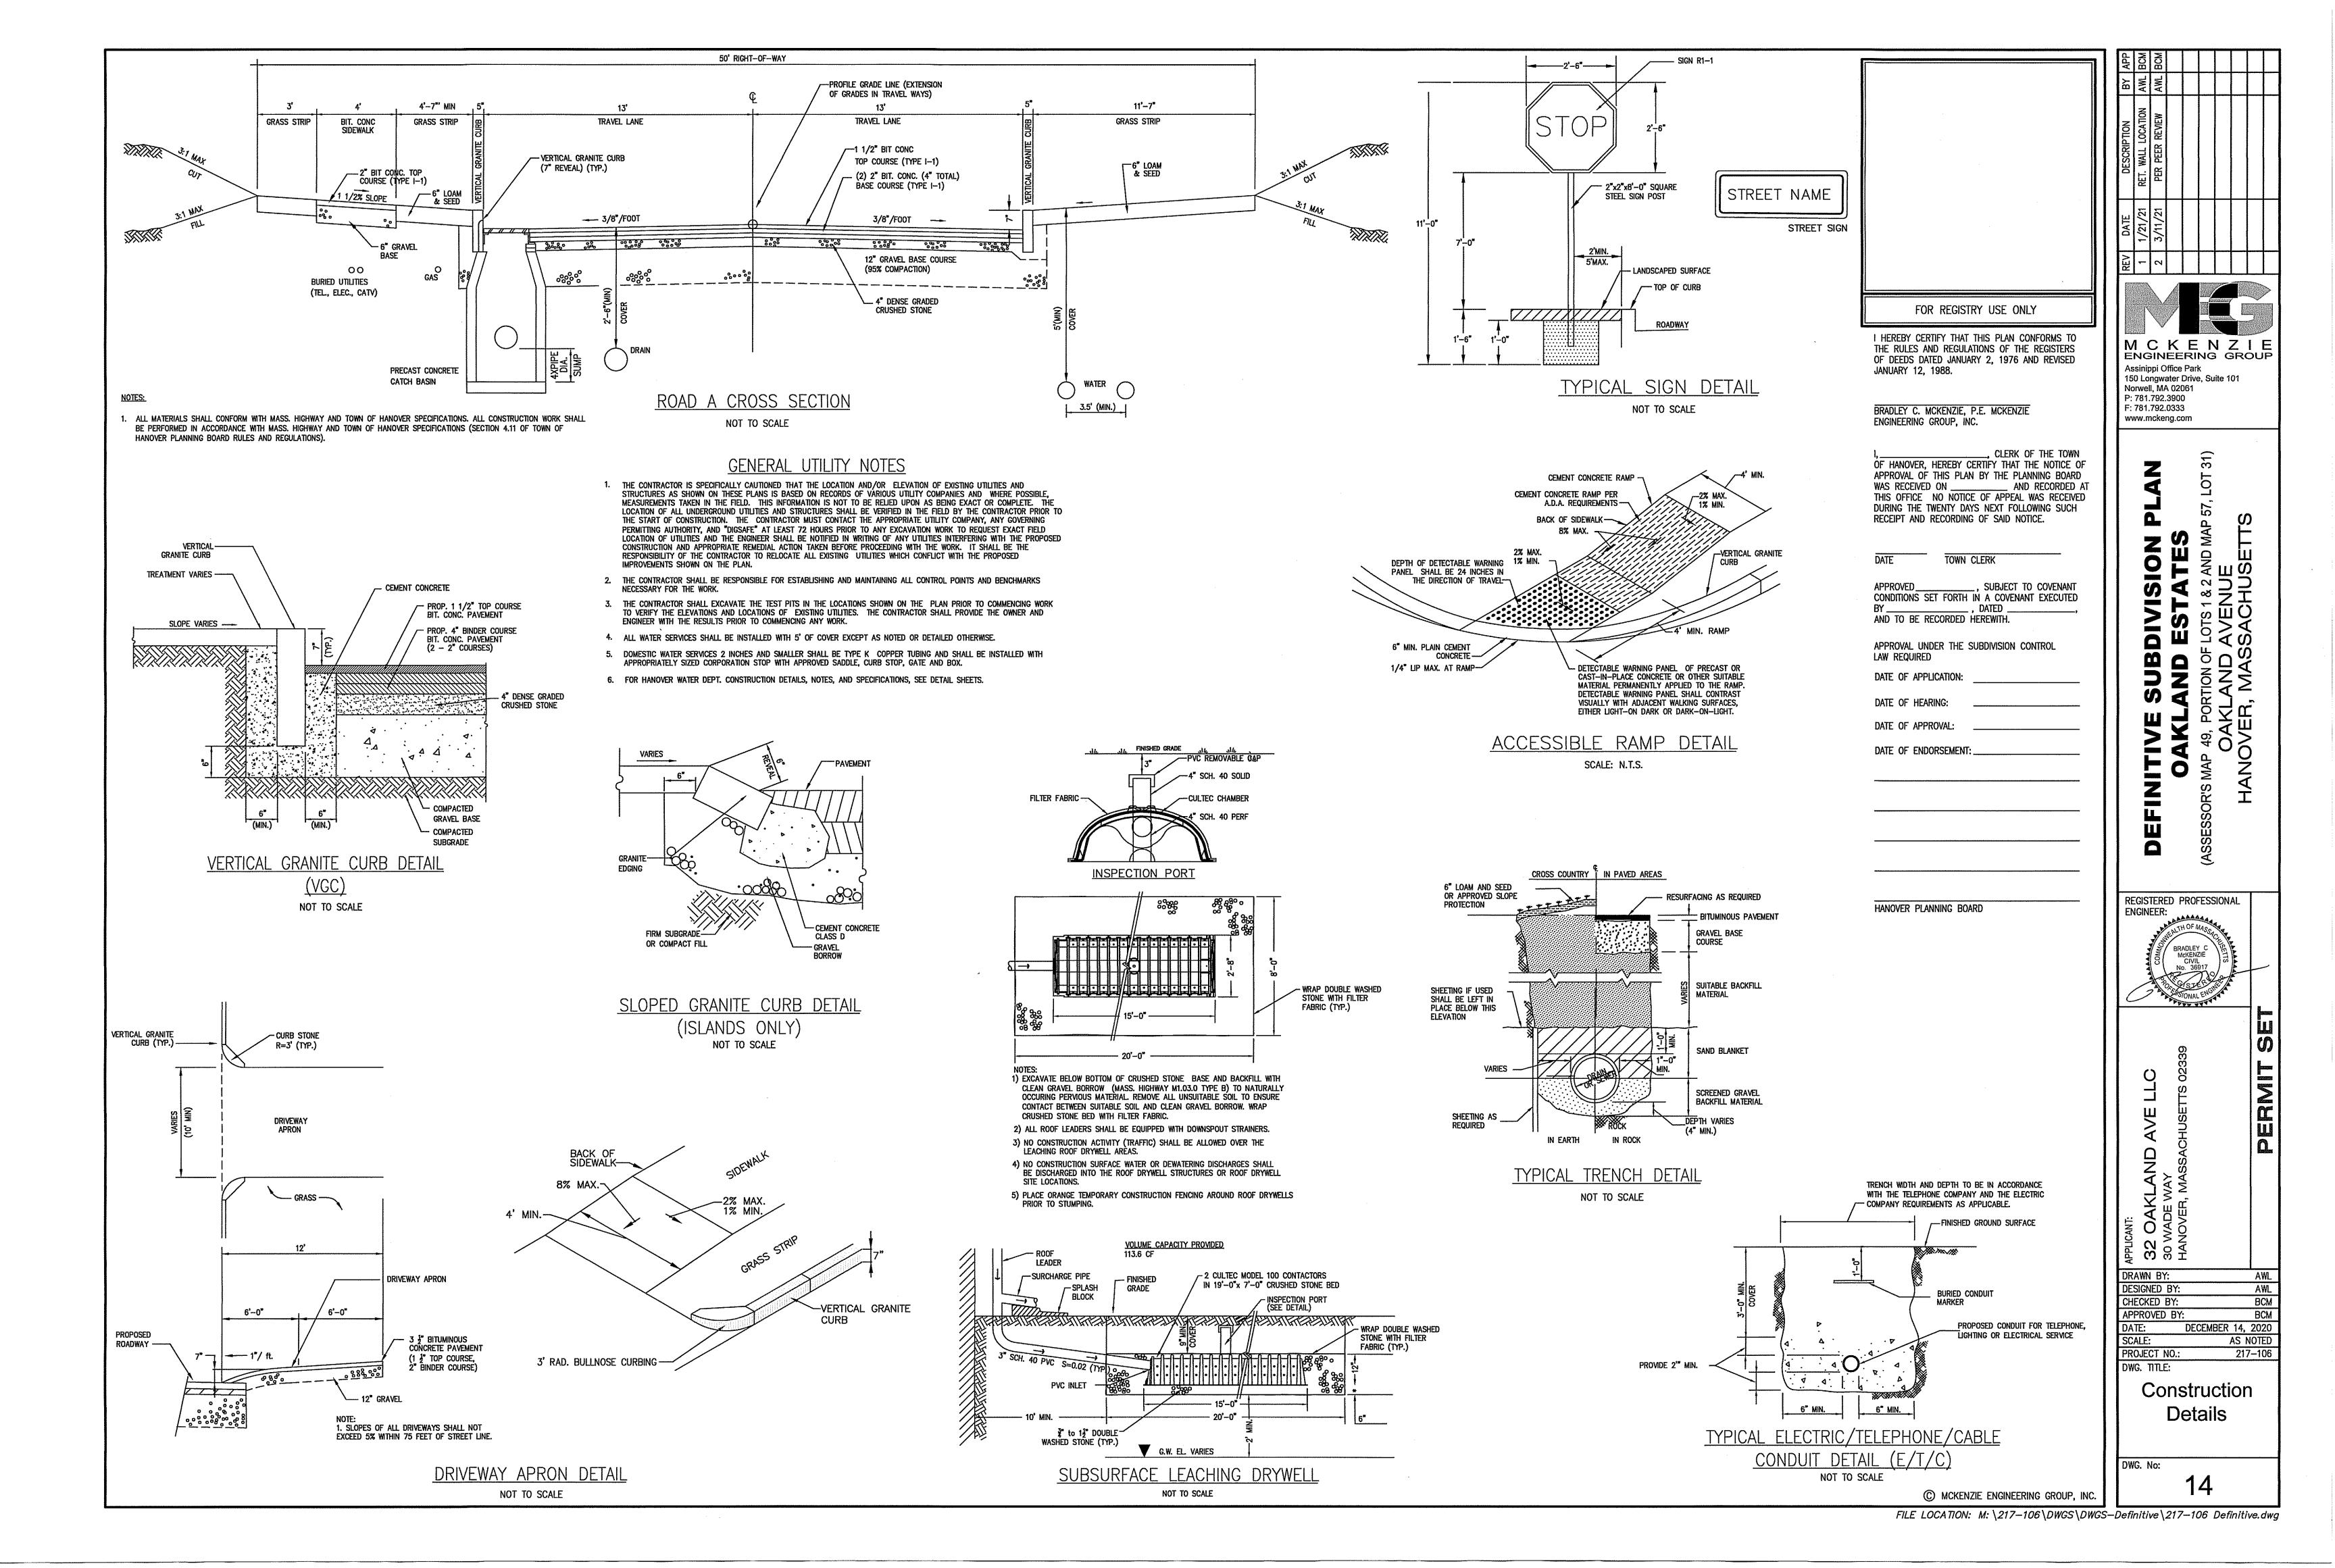
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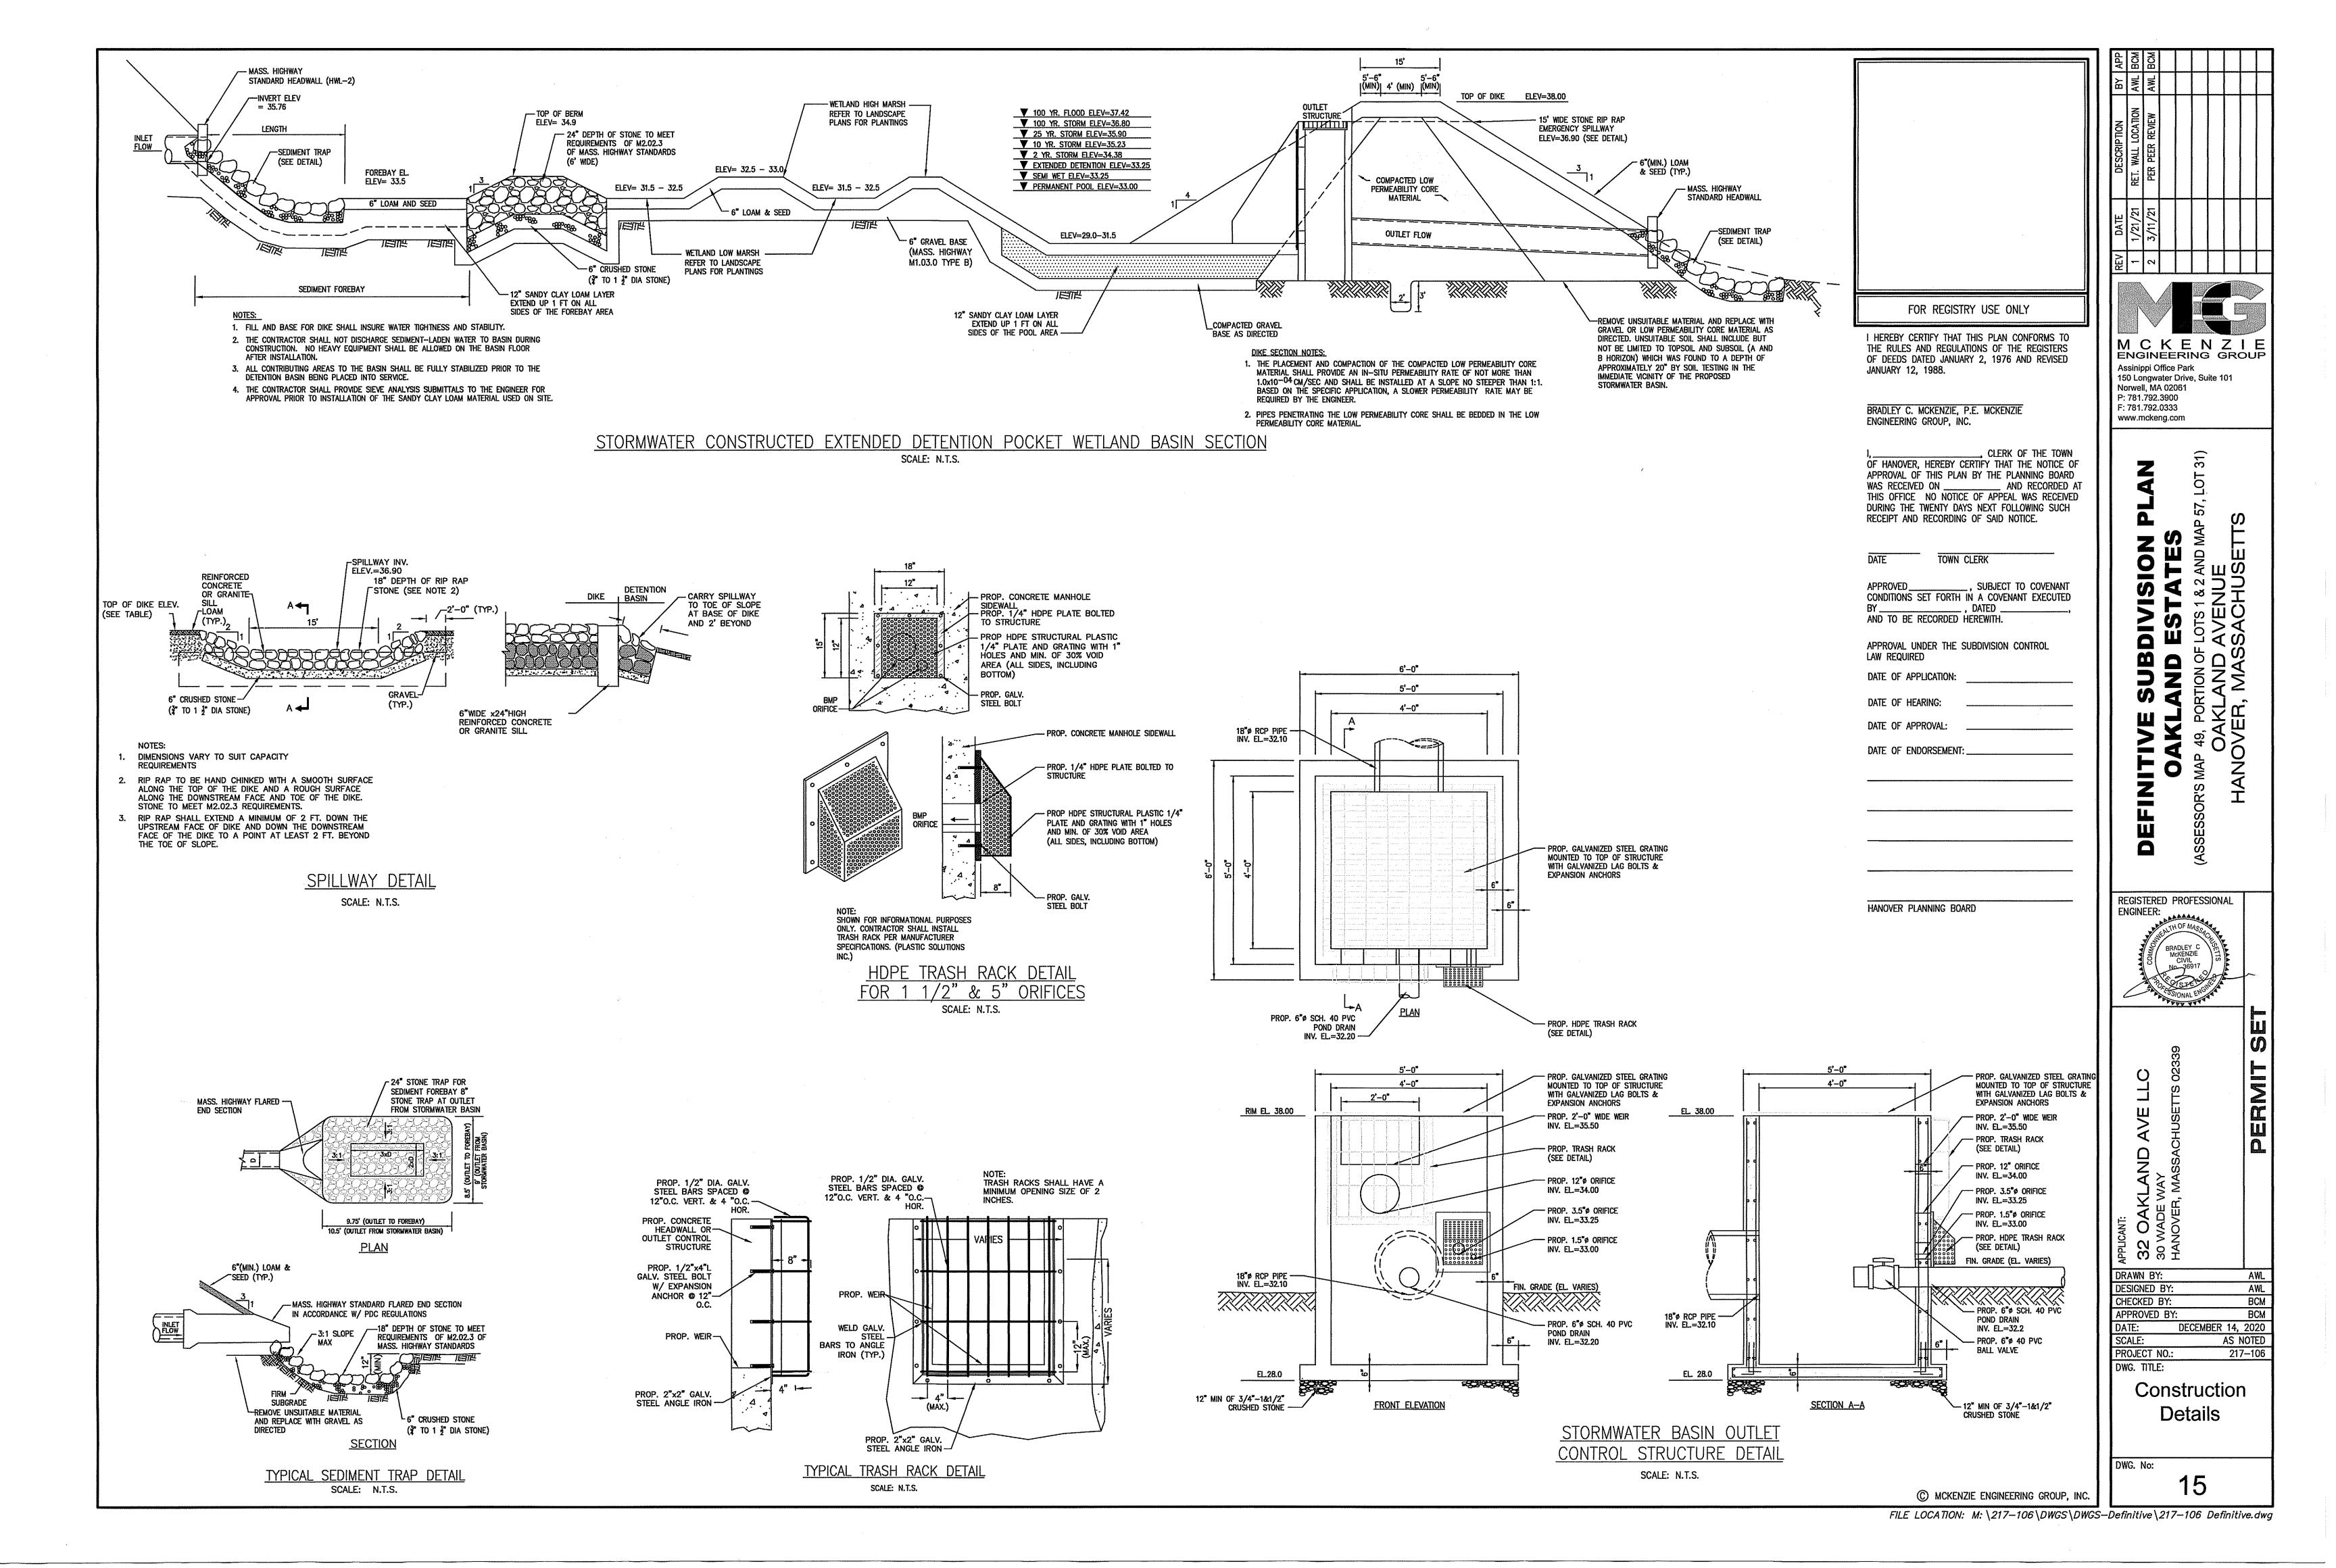
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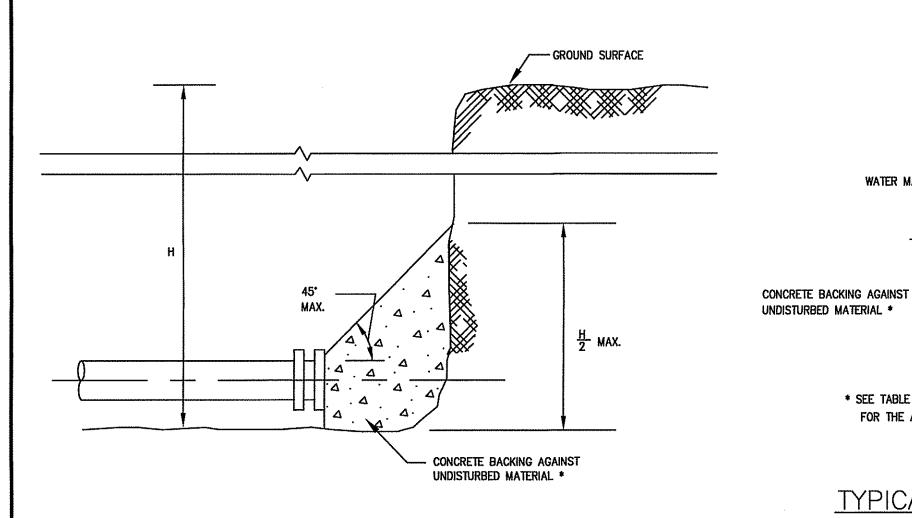
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DECEMBER 14, 2020

**Details** 

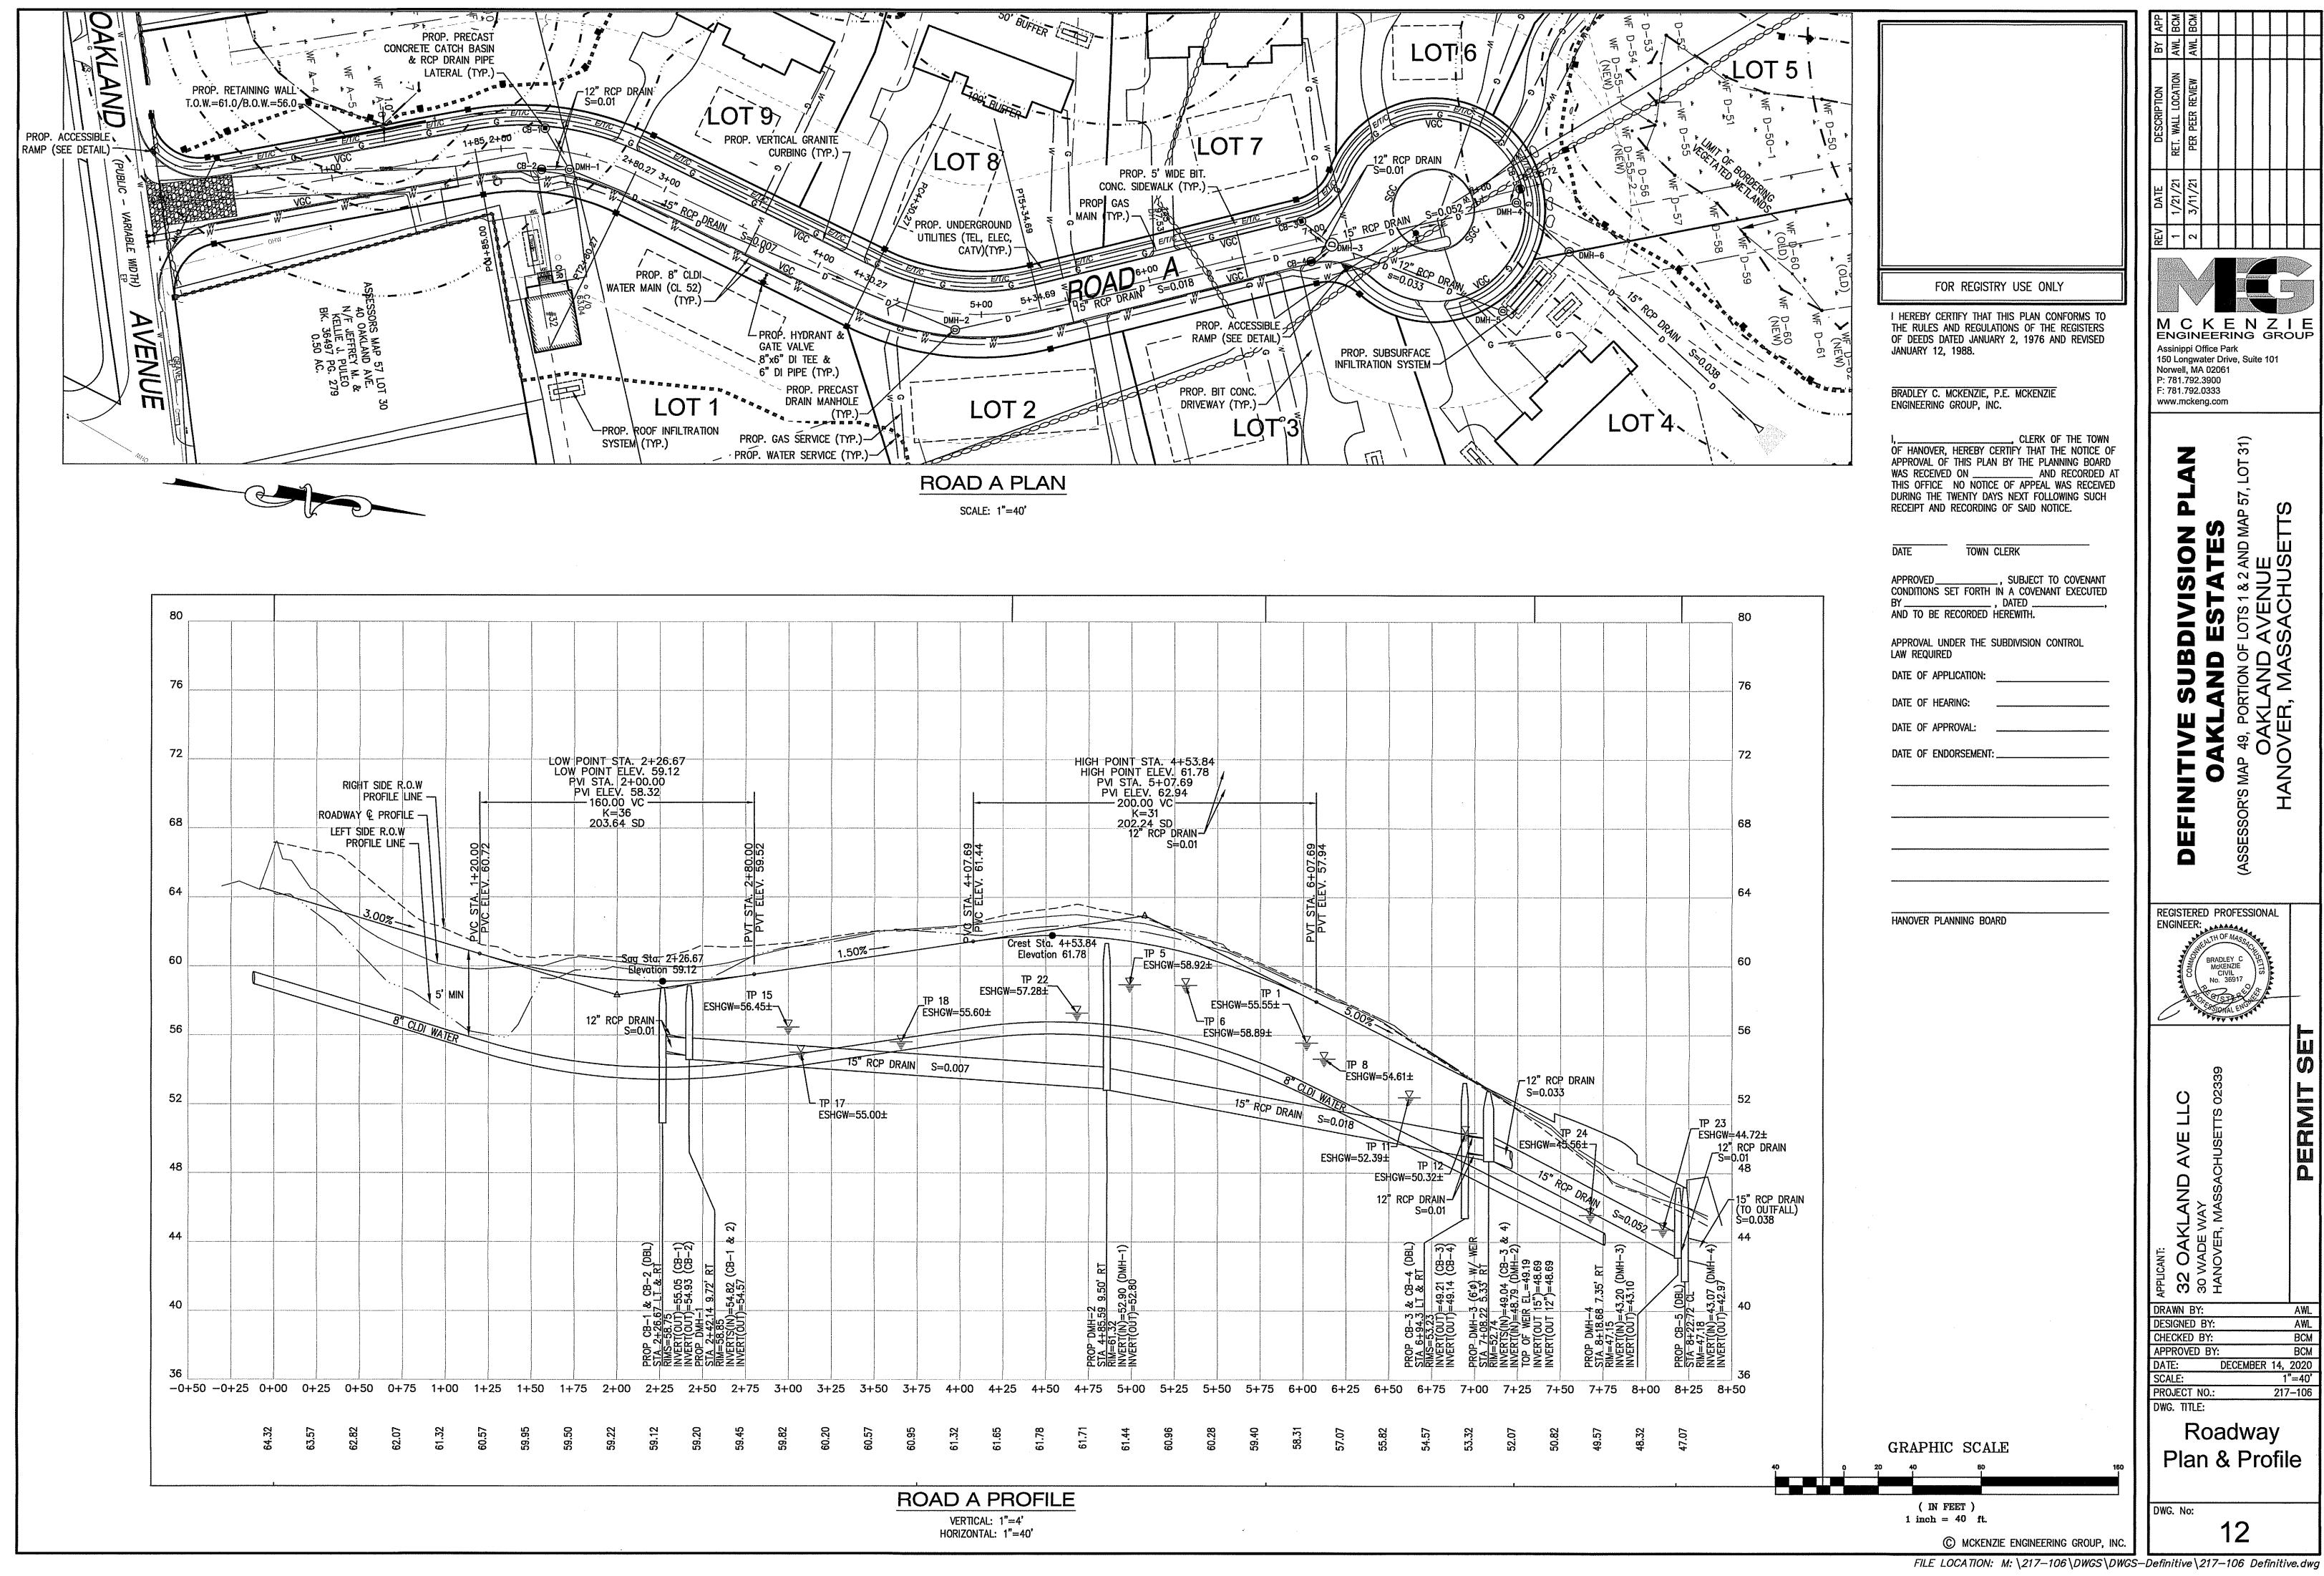


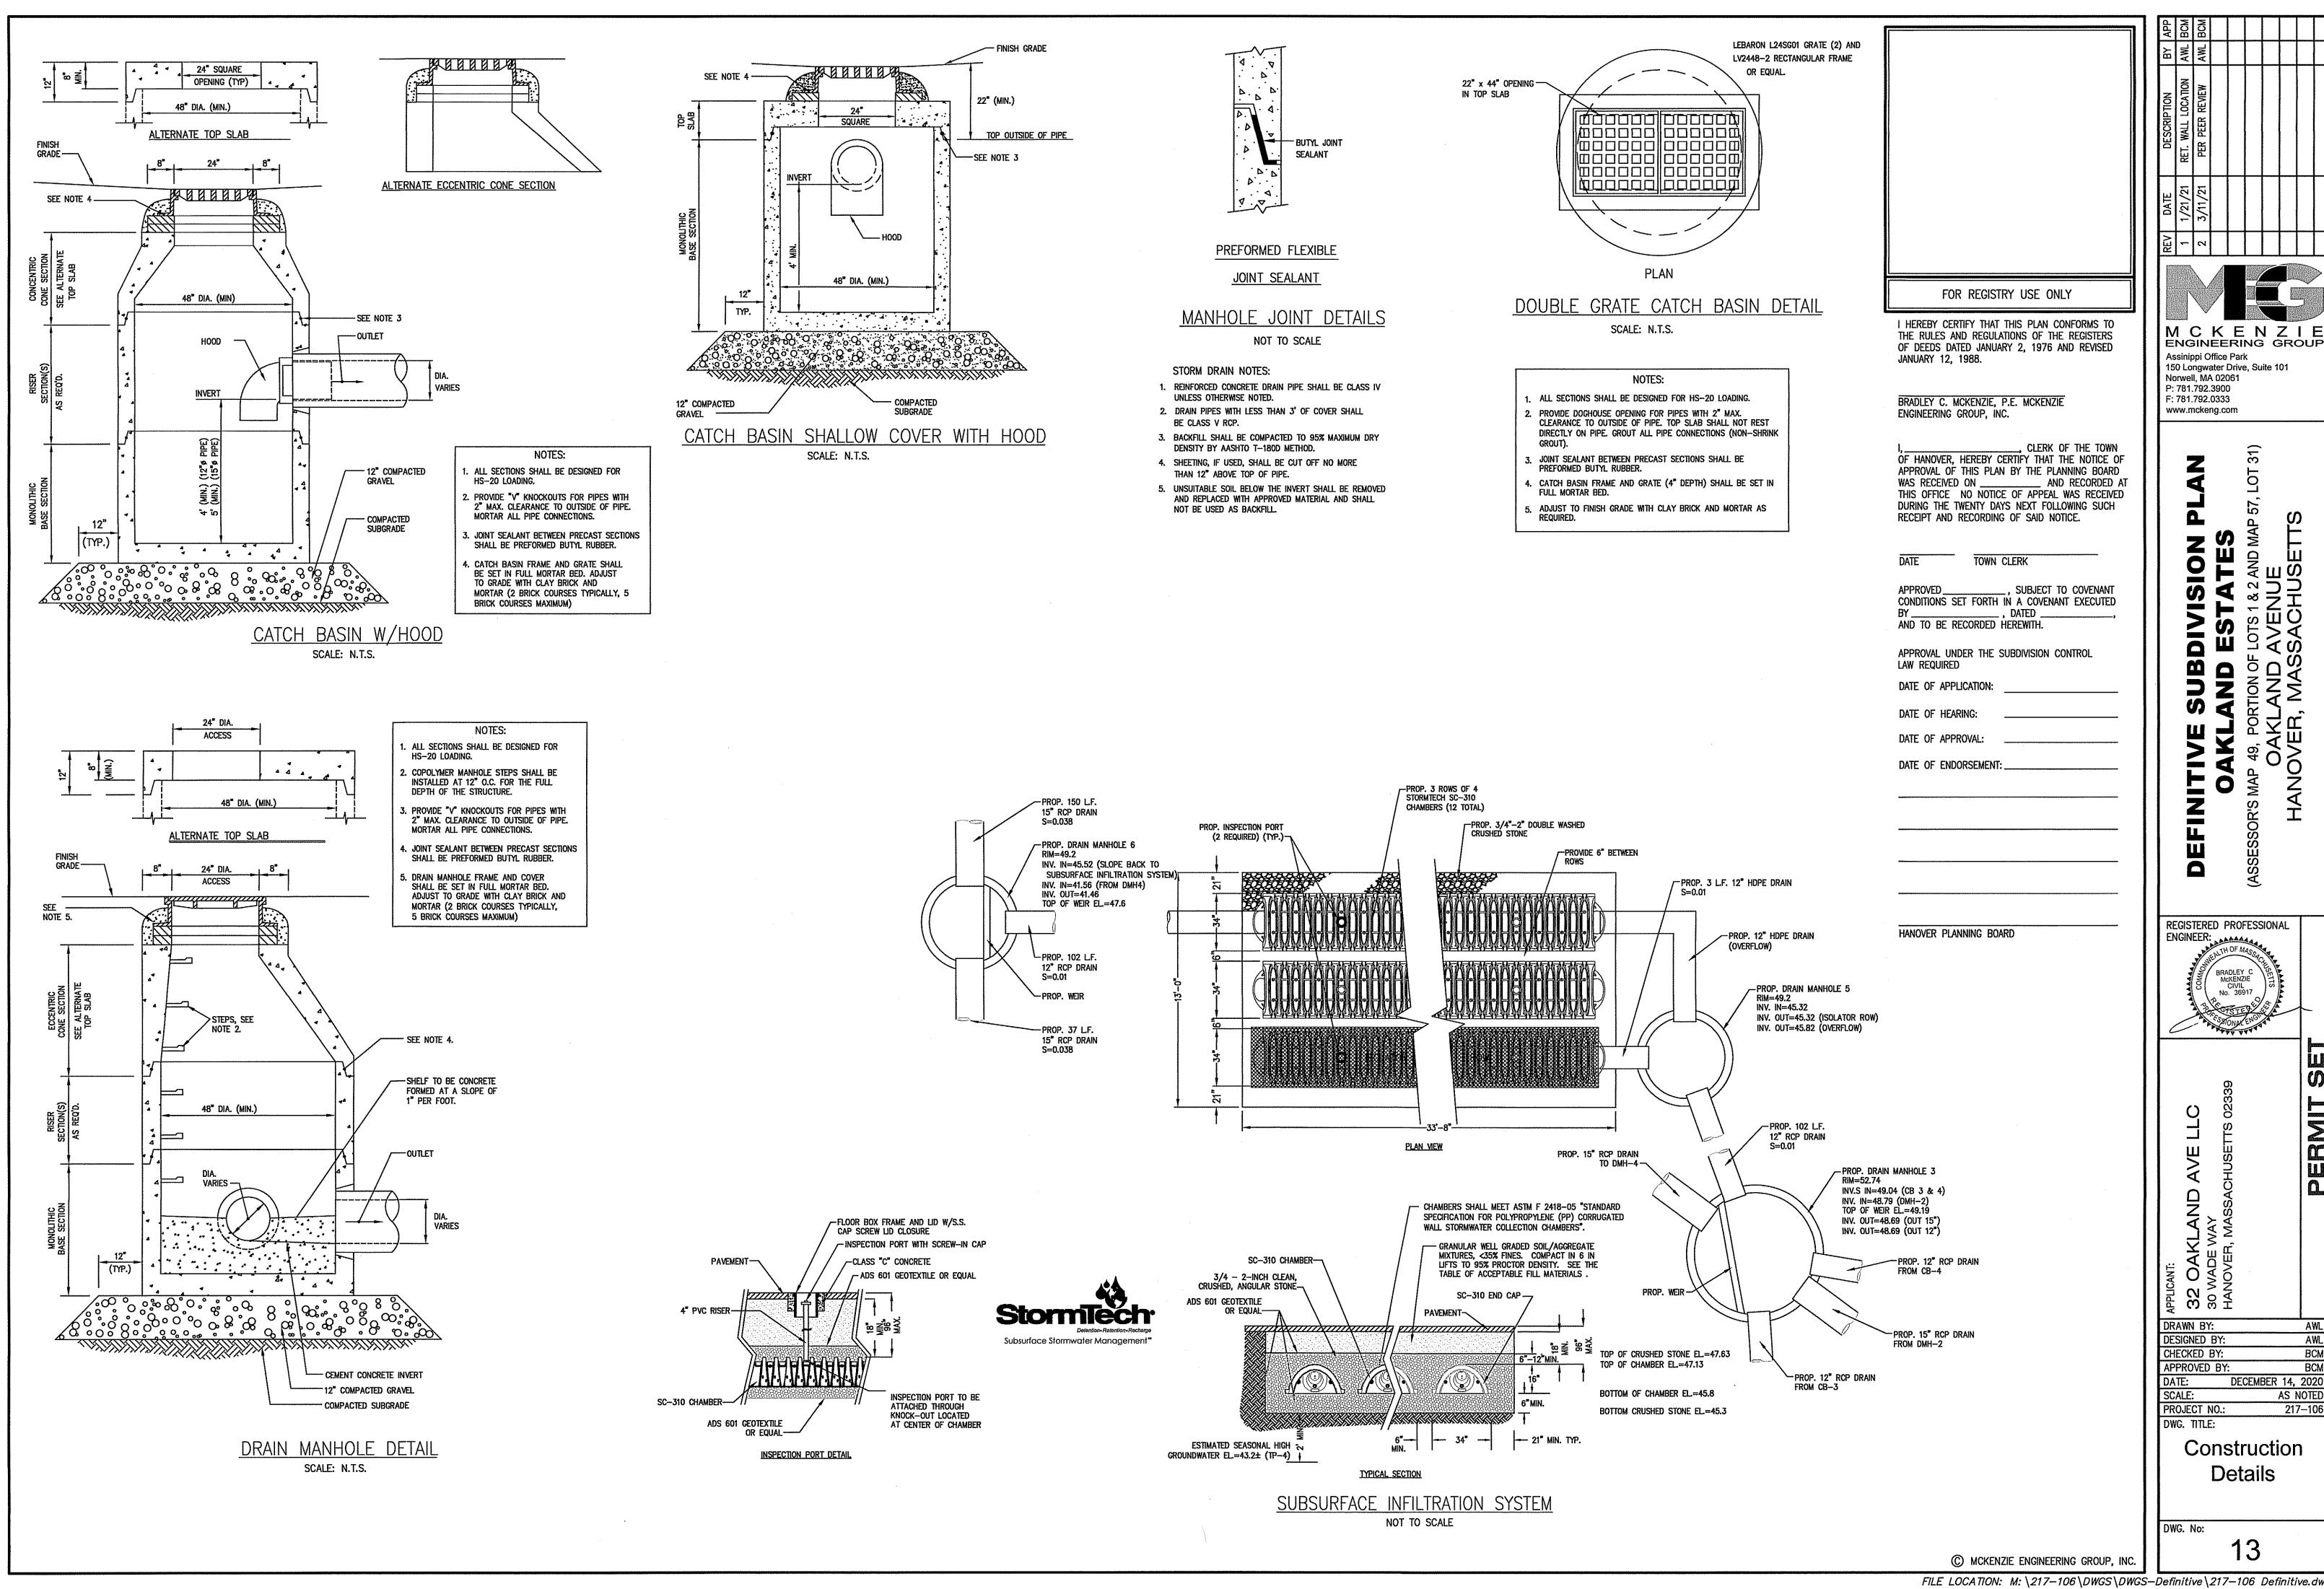



#### TYPICAL WATER MAIN PLUG

NOT TO SCALE

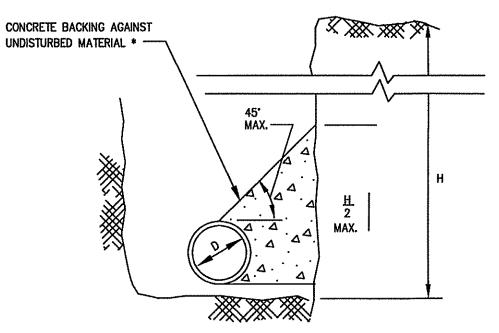



#### TYPICAL WATER MAIN THRUST BLOCK SECTION DETAILS

NOT TO SCALE

	MINAMIN	JM JIZL
	TAPPED C	ONNECTION *
	WATER MAIN DIAMETER	MAXIMUM TAP DIAMETER
	4"	1/2"
Ī	6"	3/4*
	8"	3/4"
ſ	12*	1"

WATER MAIN

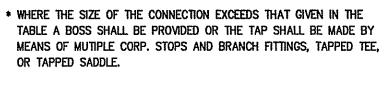


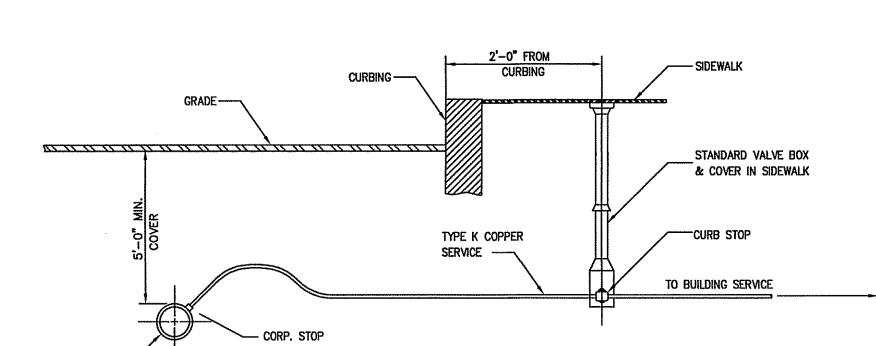

COPPER SERVICE CONNECTION NOT TO SCALE

- 1. IF SHEETING IS USED, IT SHALL BE CUT OFF NO MORE THAN 12" ABOVE TOP OF PIPE.
- 2. ALL PIPES SHALL BE PRESSURE TESTED AT 200 PSI WORKING PRESSURE FOR A MINIMUM DURATION OF TWO HOUR.
- 3. WATER SYSTEM IS TO BE DISINFECTED TO 50 P.P.M. AVAILABLE CHLORINE AND AFTER 24 HOURS TO 25 P.P.M. OR AS REQUIRED BY HANOVER WATER SUPERINTENDENT/ENGINEER.
- 4. WATER PIPE IS TO BE CEMENT LINED DUCTILE IRON "TYTON" OR EQUAL TYPE JOINT, CONFORMING TO A.N.S.I./A.W.W.A. C150/A21.50, CLASS 52, AS APPROVED BY THE HANOVER WATER SUPERINTENDENT/ENGINEER.
- 5. ALL PIPING SHALL BE INSTALLED AND TESTED IN ACCORDANCE WITH A.W.W.A. STANDARDS PRIOR TO PAVING IF PAVING ABOVE TRENCH IS REQUIRED.

#### THRUST BLOCK BEARING AREAS FOR WATER PIPE

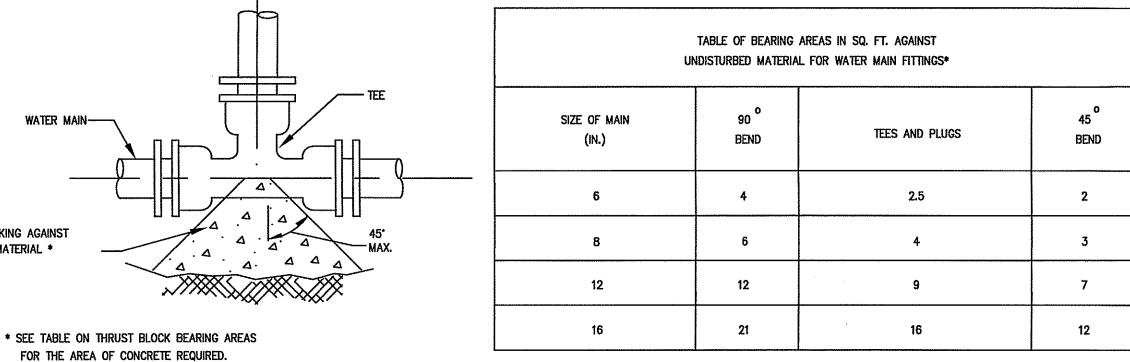

\* TYPE OF SOIL IS MEDIUM CLAYEY, 6 OR MORE BLOWS PER FOOT, OR LOOSE GRANULAR, 9 OR MORE BLOWS PER FOOT. SOIL CONDITIONS OTHER THAN THOSE GIVEN WILL REQUIRE LARGER BEARING AREAS.

#### NOTES:

- 1. FOR FITTINGS WITH LESS THAN 45 DEFLECTION, USE BEARING AREAS FOR 45 BEND.
- 2. BEARING AREAS BASED ON HORIZONTAL PASSIVE SOIL PRESSURE OF 2000 P.S.F. AND INTERNAL WATER PRESSURE OF 150 P.S.I.G. JOINTS SHALL NOT BE ENCASED IN CONCRETE. BEARING AREAS MAY BE DIREGARDED FOR TRENCHES IN ROCK WHERE THE TOP OF THE ROCK FACE IS AT OR ABOVE THE CROWN OF THE PIPE. HOWEVER, CONCRETE BACKING SHALL BE PLACED BETWEEN THE PIPE AND THE ROCK FACE.
- THE CONTRACTOR SHALL SUBMIT 2 WEEKS IN ADVANCE OF PLACEMENT, WORKING DRAWINGS FOR EACH THRUST BLOCK TO THE ENGINEER FOR APPROVAL PRIOR TO INSTALLATION.
- 4. ALL TEES, GATE VALVES, HYDRANTS AND FITTINGS SHALL BE MECHANICAL JOINTS WITH MEGA-LUGS.
- 5. THRUST BLOCKS SHALL BE BARREL BLOCKS.

# UNDISTURBED PROPOSED WATER MAIN MECHANICAL JOINT / PUSH-ON JOINT TAPPING VALVE


\_VALVE BOX OR VALVE INDICATOR

POST AS REQUIRED

PLACE MASONRY BLOCK FRAME -UNDER ACCESS PIPE ON COMPACTED FILL DO NOT REST ON VALVE - PROPOSED WATER MAIN ---- EXIST. WATER MAIN


TYPICAL TAPPING SLEEVE AND VALVE NOT TO SCALE

- 6. BACKFILL IS TO BE COMPACTED TO 90% MAXIMUM DRY DENSITY BY AASHTO T-180 D.
- 7. ALL WATER PIPE SHALL BE LAID WITH A MINIMUM OF 5 FEET OF COVER OF APPROVED MATERIALS.
- 9. RESULTS FROM PRESSURE TESTING AND DISINFECTION SHALL BE FURNISHED TO THE DIRECTOR OF PUBLIC WORKS FOR APPROVAL PRIOR TO WATER BEING TURNED ON.
- 10. ALL WORK SHALL BE IN CONFORMANCE WITH HANOVER WATER DEPARTMENT STANDARDS.

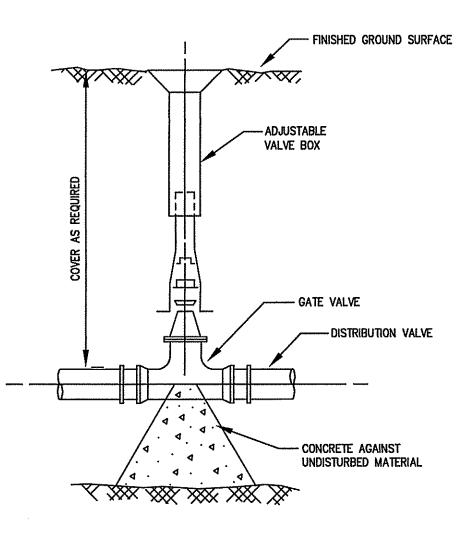

# WATER GATE DETAIL

NOT TO SCALE

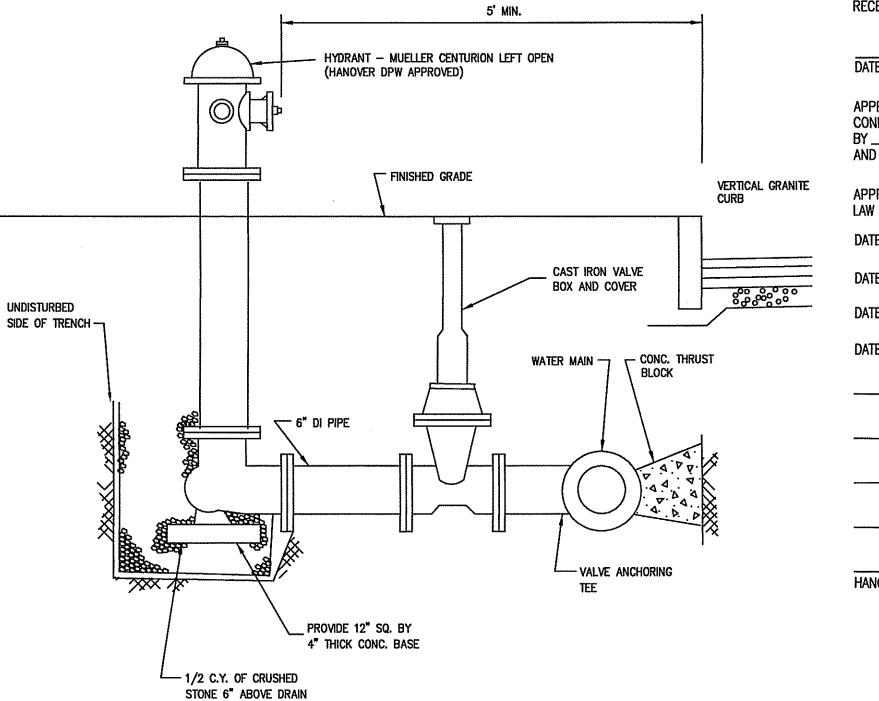

NOT TO SCALE

FOR REGISTRY USE ONLY

I HEREBY CERTIFY THAT THIS PLAN CONFORMS TO THE RULES AND REGULATIONS OF THE REGISTERS OF DEEDS DATED JANUARY 2, 1976 AND REVISED JANUARY 12, 1988.

BRADLEY C. MCKENZIE, P.E. MCKENZIE ENGINEERING GROUP, INC.

, CLERK OF THE TOWN OF HANOVER, HEREBY CERTIFY THAT THE NOTICE OF APPROVAL OF THIS PLAN BY THE PLANNING BOARD WAS RECEIVED ON \_ AND RECORDED AT THIS OFFICE NO NOTICE OF APPEAL WAS RECEIVED DURING THE TWENTY DAYS NEXT FOLLOWING SUCH RECEIPT AND RECORDING OF SAID NOTICE.

> REGISTERED PROFESSIONAL **ENGINEER:**

M C K E N Z I E ENGINEERING GROUP

Assinippi Office Park 150 Longwater Drive, Suite 101

Norwell, MA 02061

P: 781.792.3900

F: 781.792.0333

www.mckeng.com

DRAWN BY: DESIGNED BY: CHECKED BY: APPROVED BY: DECEMBER 14, 2020

AWL

BCM

BCM

AS NOTE PROJECT NO .: 217-106 DWG. TITLE:

Construction Details

16

DWG. No:

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TOWN CLERK , SUBJECT TO COVENANT CONDITIONS SET FORTH IN A COVENANT EXECUTED AND TO BE RECORDED HEREWITH. APPROVAL UNDER THE SUBDIVISION CONTROL LAW REQUIRED DATE OF APPLICATION: DATE OF HEARING: DATE OF APPROVAL: DATE OF ENDORSEMENT: HANOVER PLANNING BOARD HYDRANT DETAIL

GENERAL NOTES

WATER MAIN-

CONCRETE BACKING AGAINST UNDISTURBED MATERIAL

WHERE NO PAVED SIDEWALK

EXIST CURB STOPS & VALVE

BOXES TO BE INSTALLED IN

\* SEE TABLE ON THRUST BLOCK BEARING AREAS FOR THE AREA OF CONCRETE REQUIRED.

TYPICAL WATER MAIN BEND

THRUST BLOCK DETAILS

NOT TO SCALE

MECHANICAL JOINT TAPPING SLEEVE -

TYPICAL WATER MAIN TEE


THRUST BLOCK DETAILS


NOT TO SCALE

8. ALL HYDRANT LOCATIONS ARE TO BE APPROVED BY FIRE DEPARTMENT.

11. ALL PERMITS REQUIRED FOR STREET OPENINGS AND WATER MAIN TAPPING MUST BE OBTAINED.

12. NO WATER WILL BE TURNED ON IN THE PROJECT WITHOUT WATER DEPARTMENT APPROVAL.

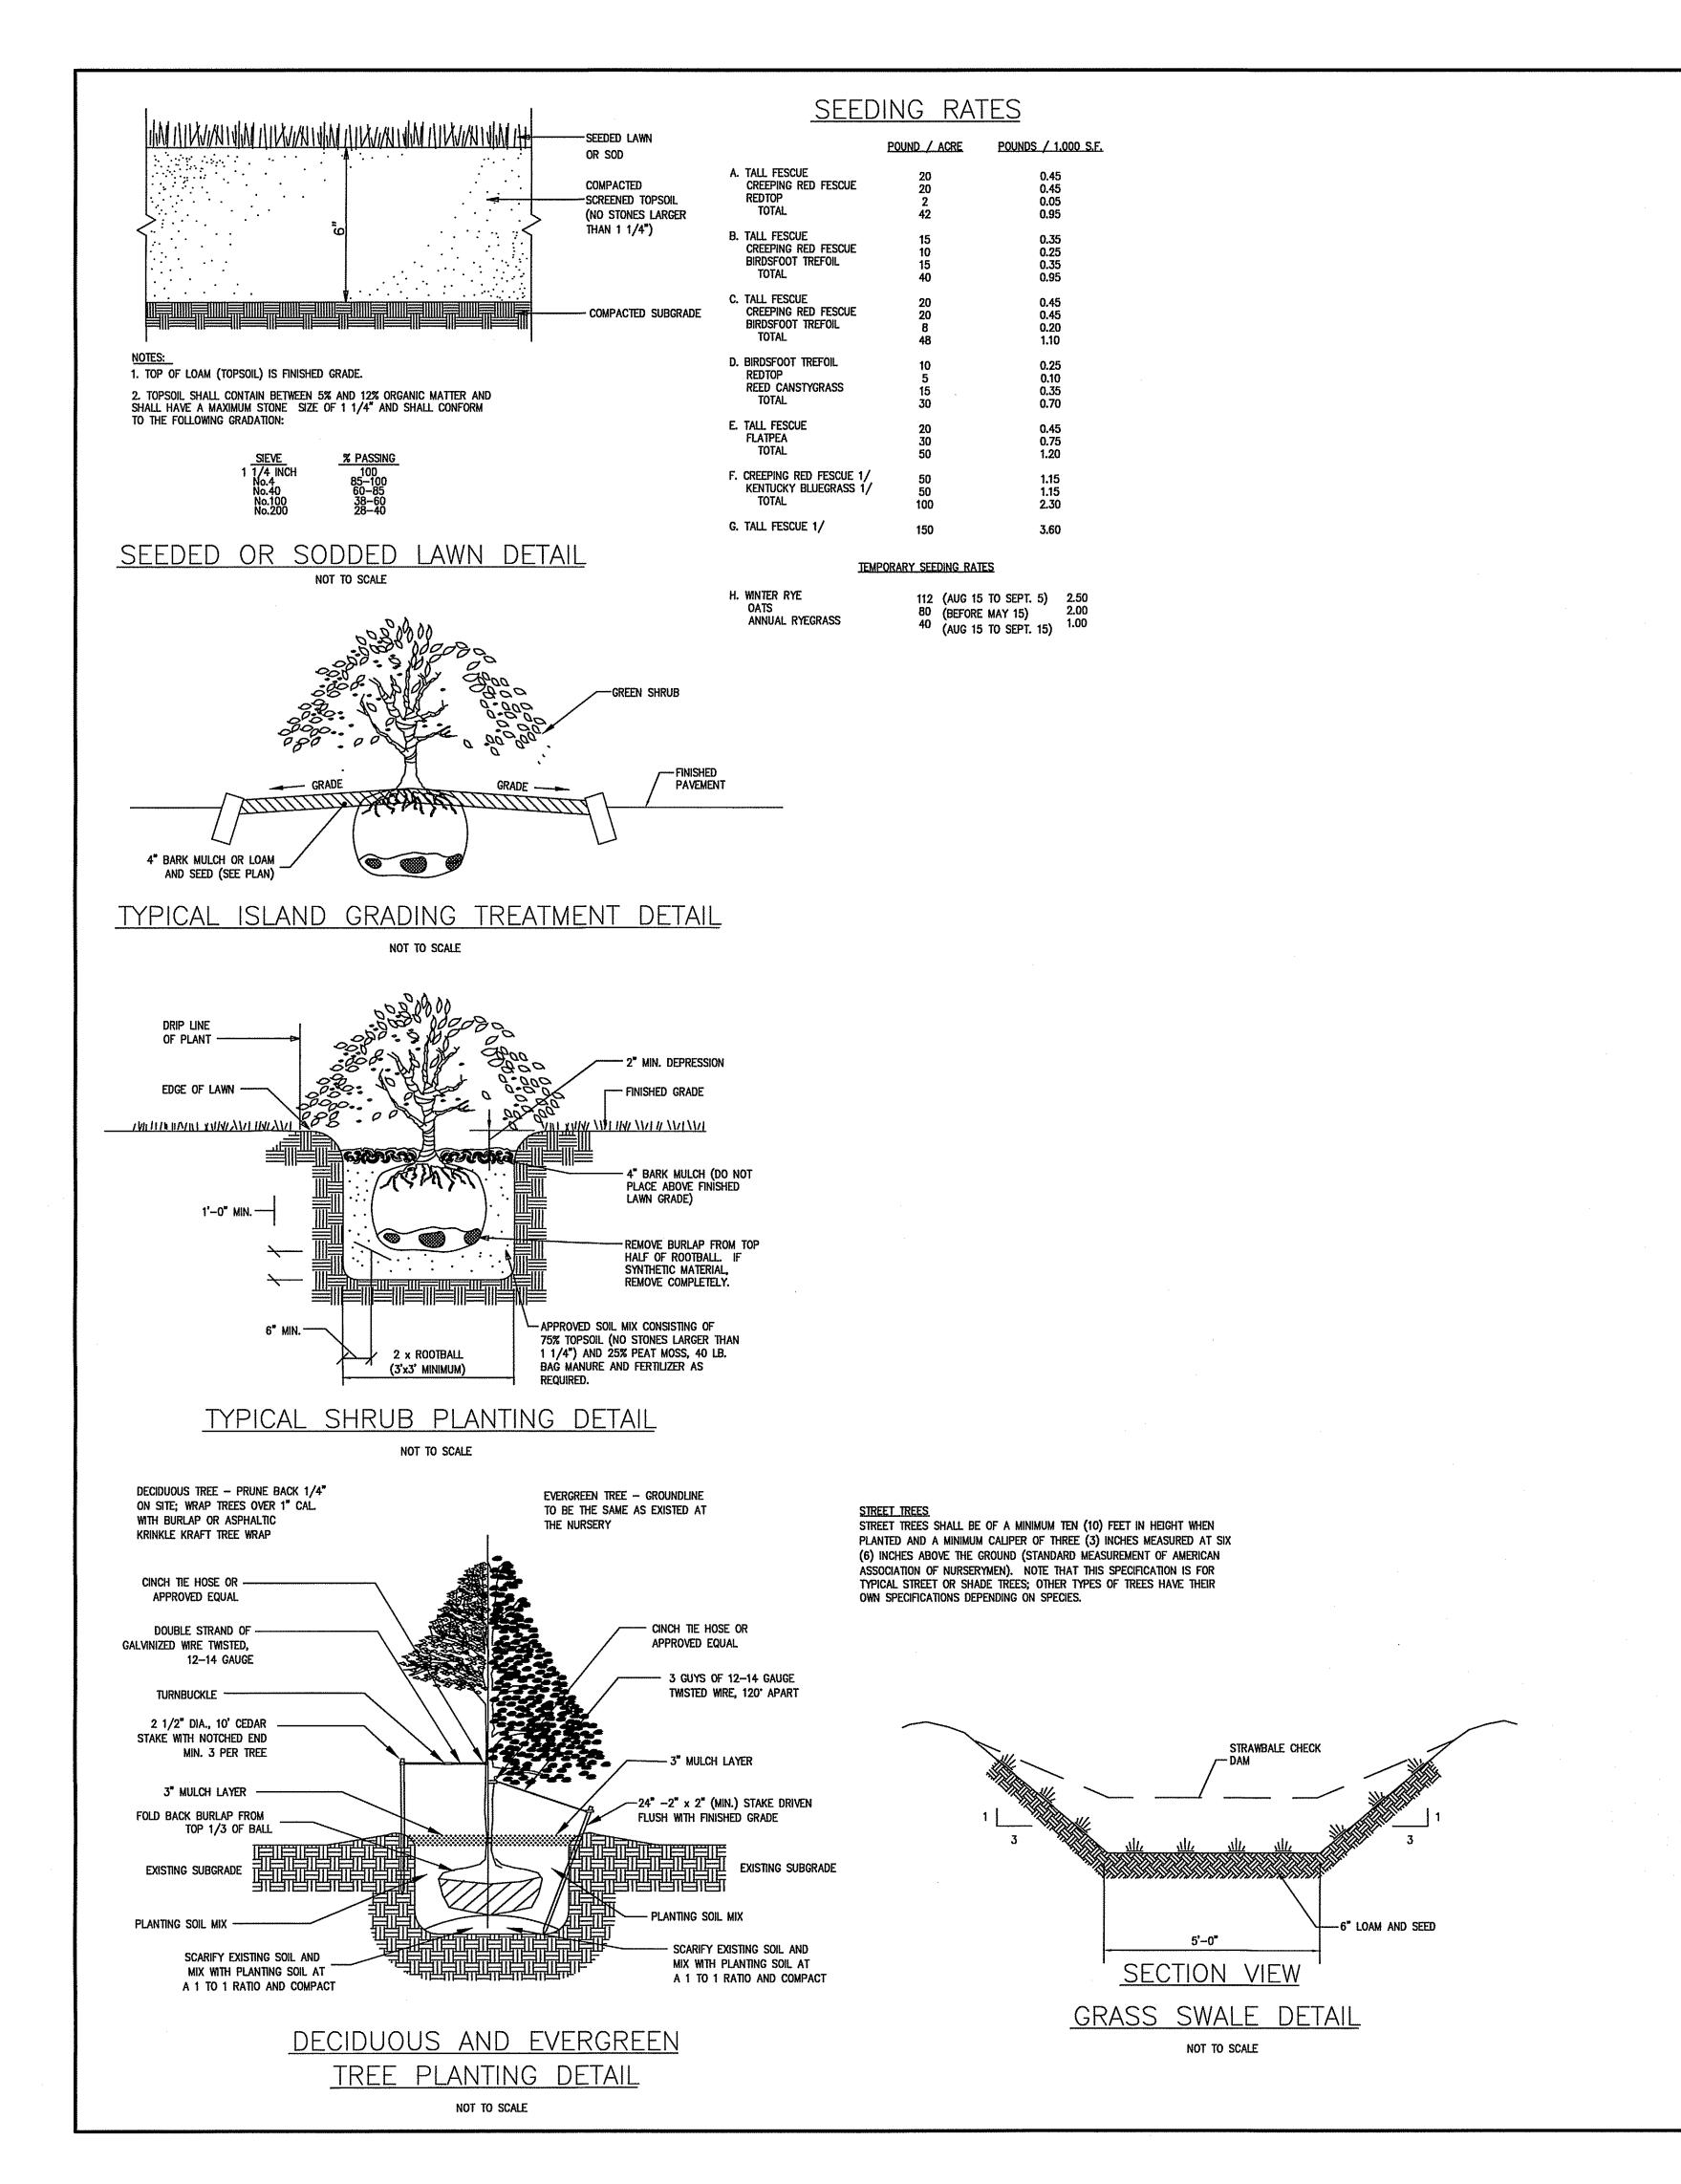

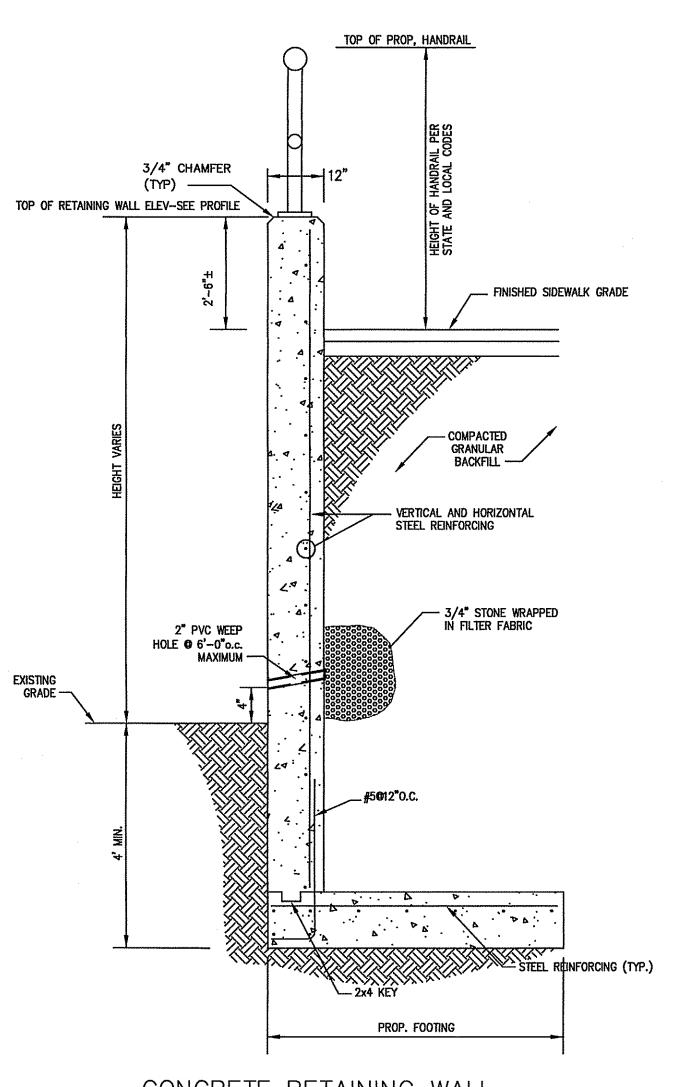

CONCRETE RETAINING WALL NOT TO SCALE

#### <u>NOTES</u>


- 1. CONCRETE 3000 PSI, 3/4" AGGREGATE
- 2. STEEL REINFORCEMENT TO BE 60,000 PSI.
- 3. ALL UNSUITABLE MATERIAL UNDER PROPOSED FOOTING TO BE REMOVED AND REPLACE WITH CRUSHED STONE.
- 4. DIMENSIONS OF WALL AND REINFORCING TO BE DESIGNED BY A REGISTERED PROFESSIONAL STRUCTURAL ENGINEER PRIOR TO

L = THE DISTANCE SUCH THAT POINTS

TYPICAL STONE CHECK DAM DETAIL

NOT TO SCALE

A & B ARE OF EQUAL ELEVATION

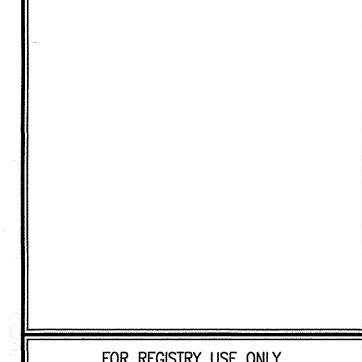

FOR REGISTRY USE ONLY

I HEREBY CERTIFY THAT THIS PLAN CONFORMS TO THE RULES AND REGULATIONS OF THE REGISTERS OF DEEDS DATED JANUARY 2, 1976 AND REVISED JANUARY 12, 1988.

BRADLEY C. MCKENZIE, P.E. MCKENZIE ENGINEERING GROUP, INC.

CLERK OF THE TOWN OF HANOVER, HEREBY CERTIFY THAT THE NOTICE OF APPROVAL OF THIS PLAN BY THE PLANNING BOARD WAS RECEIVED ON \_\_\_\_ THIS OFFICE NO NOTICE OF APPEAL WAS RECEIVED DURING THE TWENTY DAYS NEXT FOLLOWING SUCH RECEIPT AND RECORDING OF SAID NOTICE.

, SUBJECT TO COVENANT CONDITIONS SET FORTH IN A COVENANT EXECUTED AND TO BE RECORDED HEREWITH.

APPROVAL UNDER THE SUBDIVISION CONTROL LAW REQUIRED

DATE OF APPLICATION:

DATE OF HEARING:

DATE OF APPROVAL:

DATE OF ENDORSEMENT:

HANOVER PLANNING BOARD

M C K E N Z I E ENGINEERING GROUP

Assinippi Office Park 150 Longwater Drive, Suite 101 Norwell, MA 02061 P: 781.792.3900 F: 781.792.0333 www.mckeng.com

> 31) NOISIN

REGISTERED PROFESSIONAL ENGINEER:

32 O 30 WA HANO!

DRAWN BY: AWL DESIGNED BY: AWL ВСМ CHECKED BY: BCM APPROVED BY: DECEMBER 14, 2020 SCALE: AS NOTED


PROJECT NO.: DWG. TITLE:

> Construction Details

217-106

DWG. No:


© MCKENZIE ENGINEERING GROUP, INC

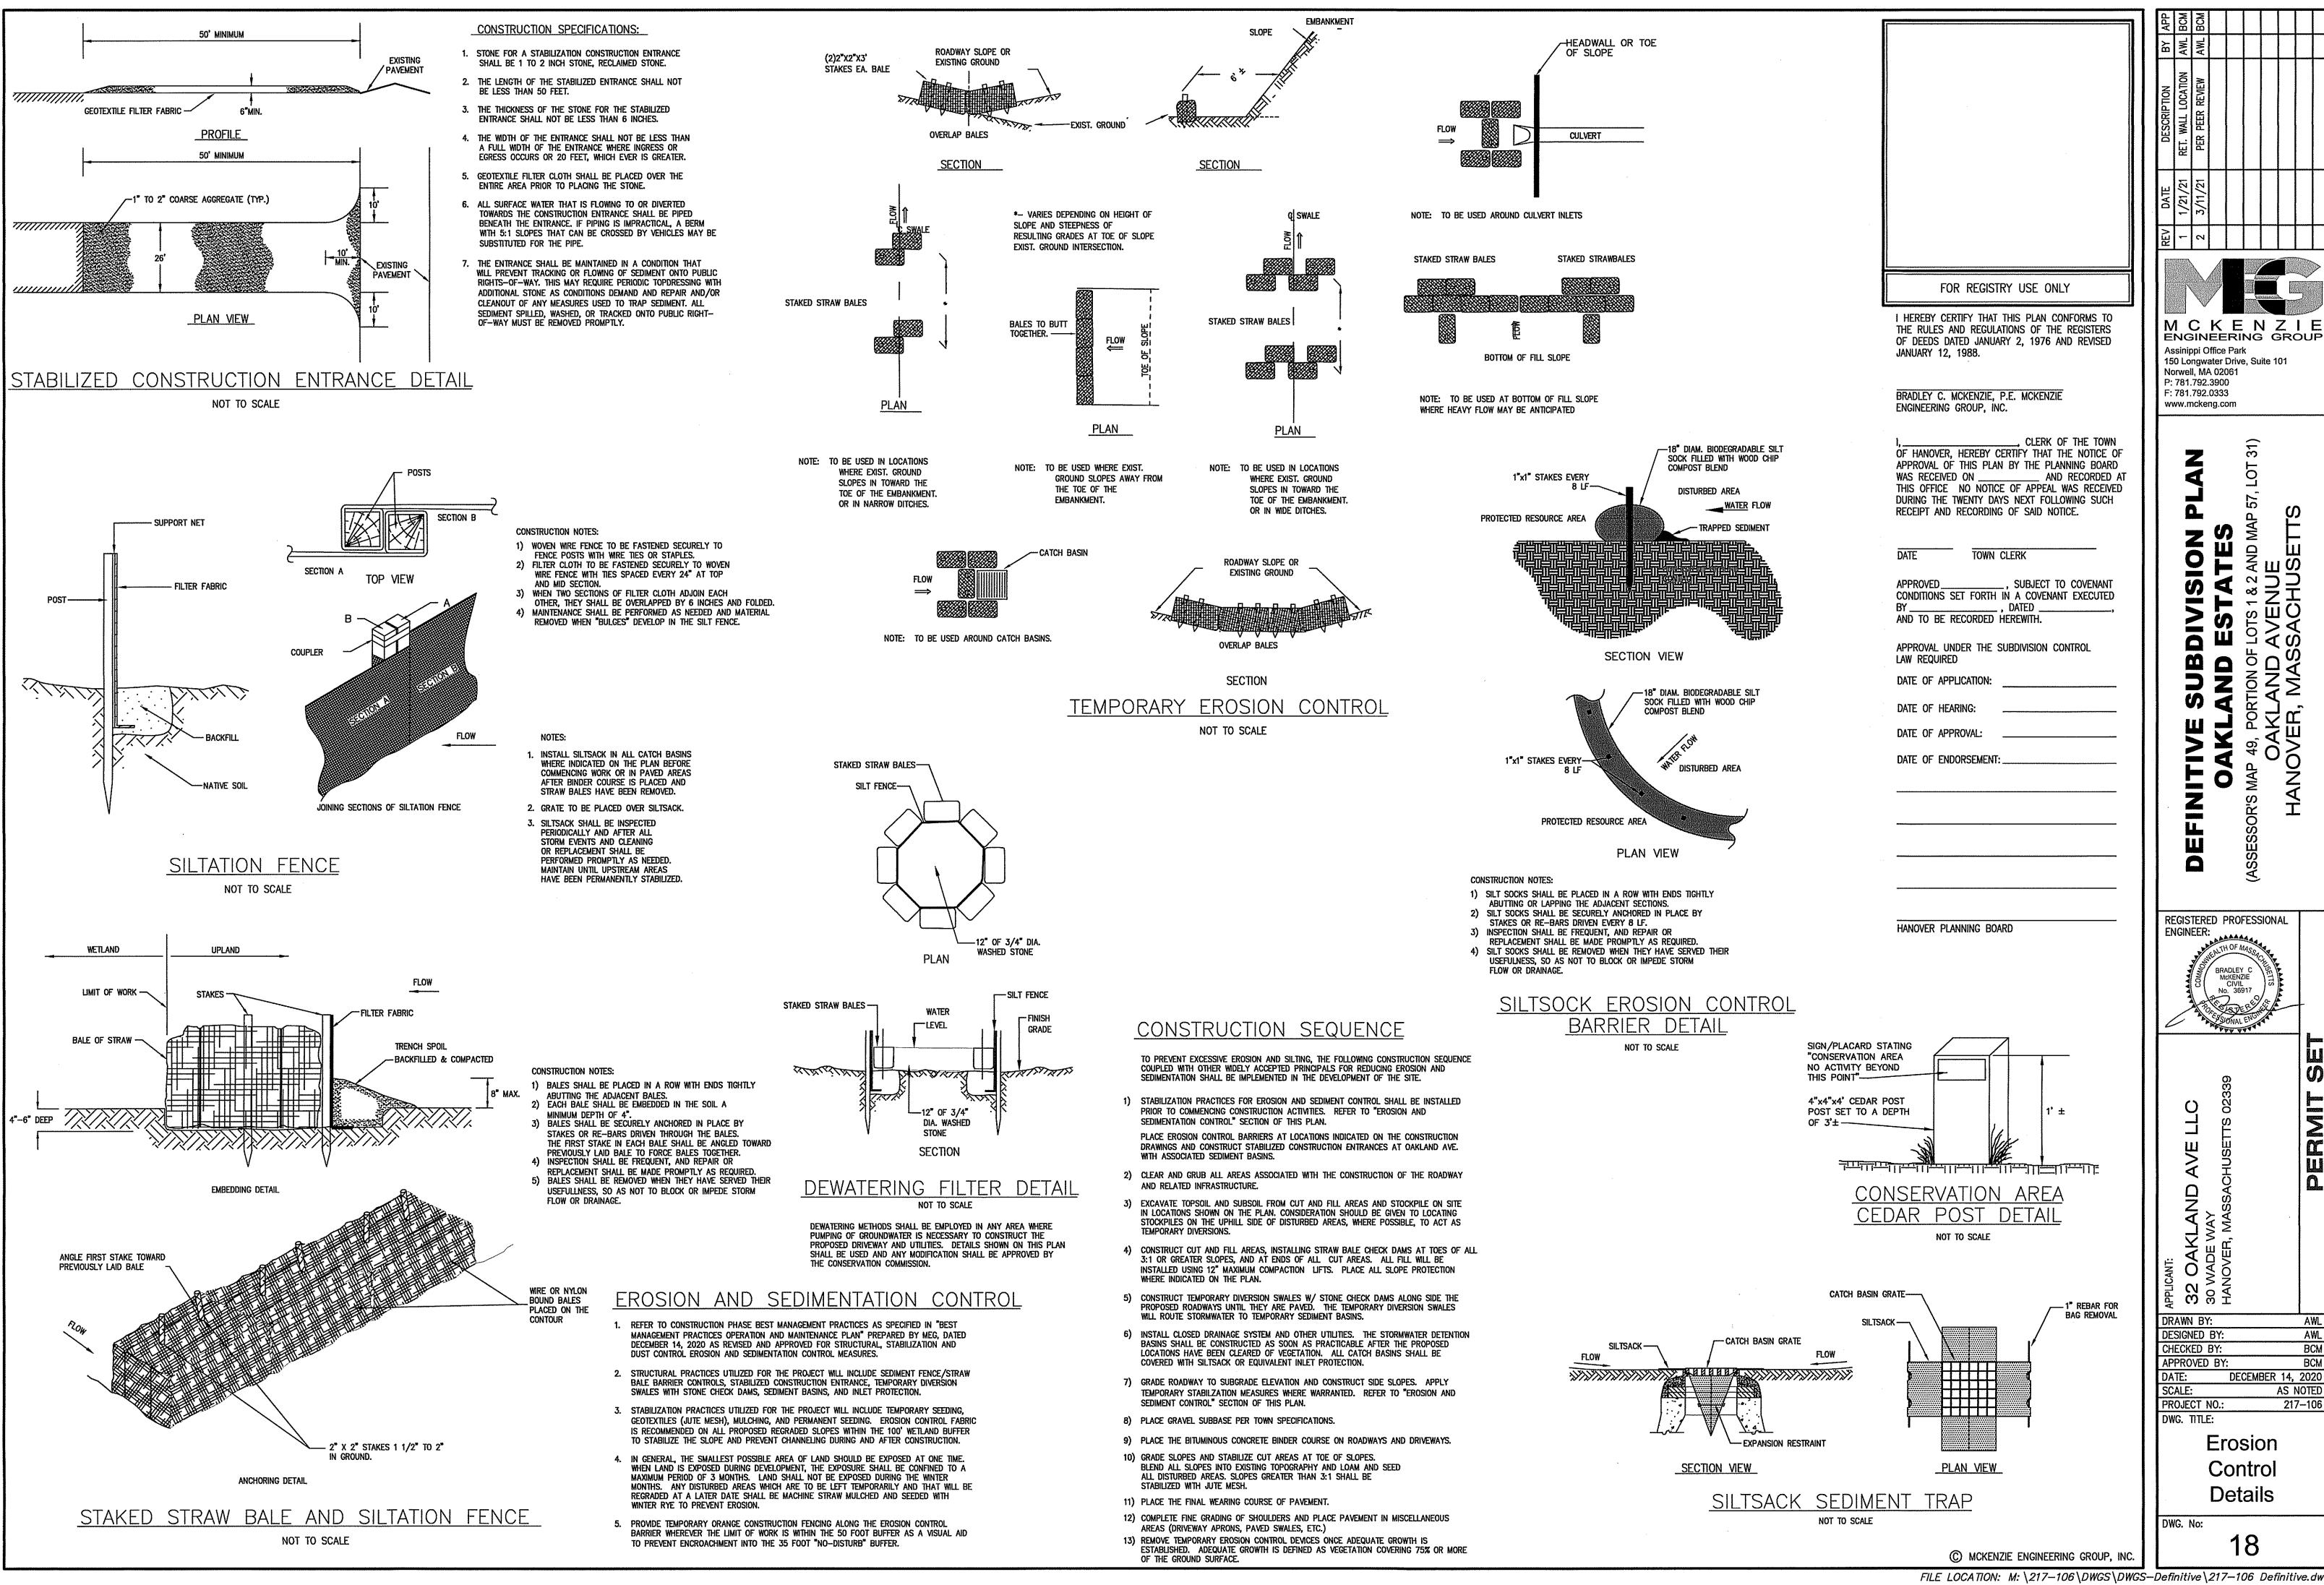


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BCM

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PLANTING PLAN FOR CUL-DE-SAC SCALE: 1" = 20'


GRAPHIC SCALE ( IN FEET ) 1 inch = 20 ft.

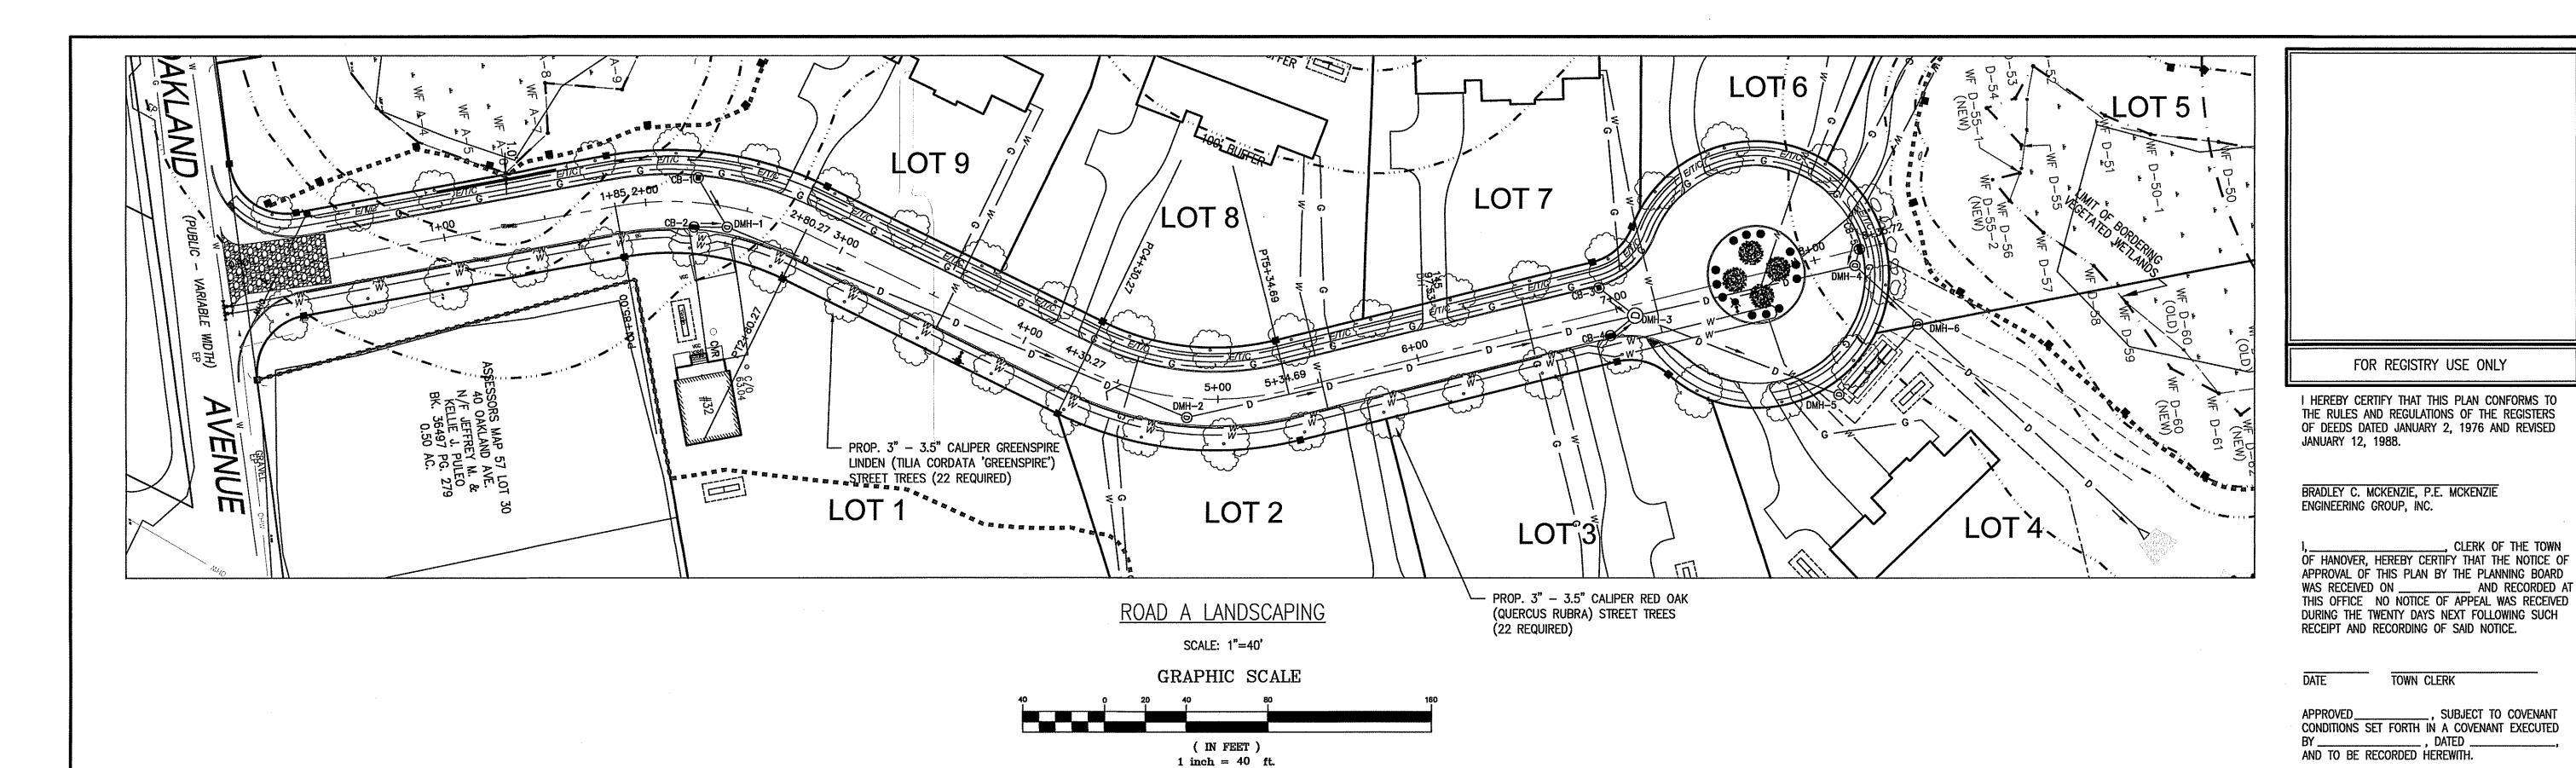
#### PLANTING SCHEDULE STORMWATER BASIN-1

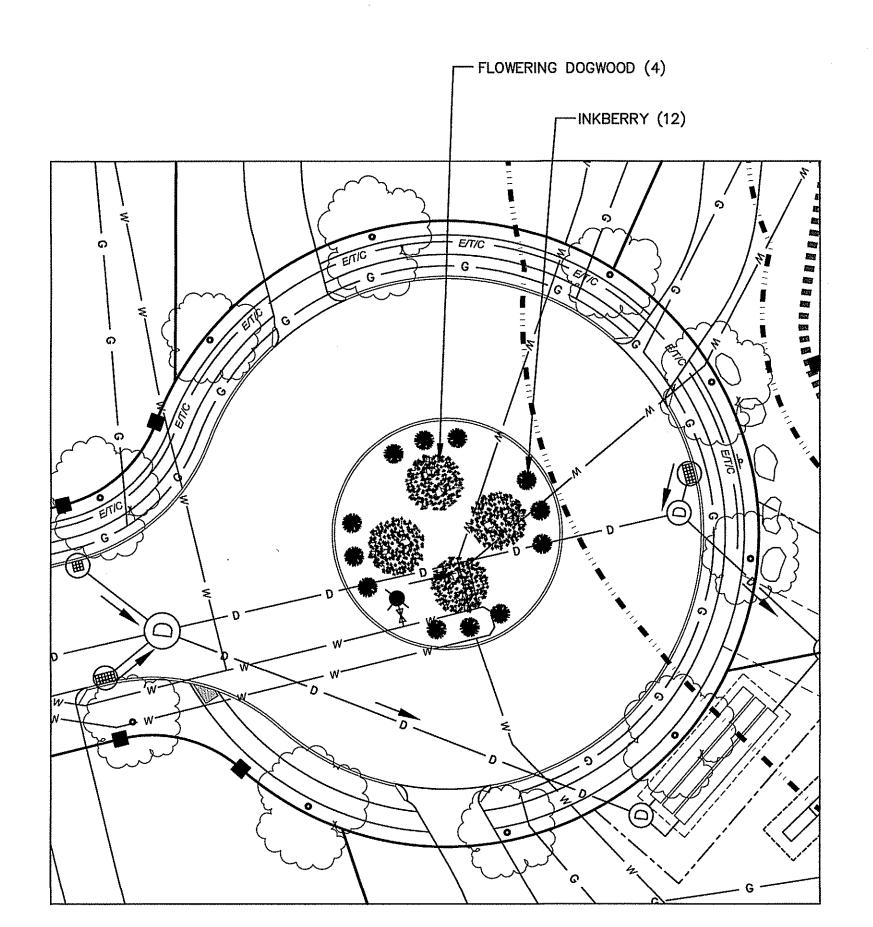TYPE	NAME	ABBREV.	SIZE	NUMBER OF SPECIMENS
Low Marsh	Soft-stem bulrush / Schoenoplectus tabernaemontani	SB	2" PLUG	120
	Hard-stem bulrush / Schoenoplectus acutus	HS	2" PLUG	120
	Common three square / Schoenoplectus pungens	SP	2" PLUG	120
	Burreed / Sparganium americanum	SA	2" PLUG	180
	Sweet flag / Acorus americana	AA	2" PLUG	180
High Marsh	Hydroseed with New England Wetland Mix at 1 lb/1250 square feet		SEED	
Side Slopes	Hydroseed with New England Erosion Control/Restoration Mix at 1 lb/1250 square feet		SEED	
Shrubs	Highbush Blueberry / Vaccinium corymbosum	НВ	1.5-2 FT.	10
	Inkberry / Rex glabra	ΙB	1.5-2 FT.	9
	Red Chokeberry / Aronia arbutifolia	RC	1.5-2 FT.	9
	Silky Dogwood / Cornus amommum	SD	1.5-2 FT.	9

#### PLANTING NOTES

- The project supervisor shall hold a pre—construction conference with the contractor to ensure all aspects of the project, as well as any Order of Conditions issued by the Norwell Conservation Commission are understood. Equipment needs and access routes to the proposed replication area shall be firmly established.
- 2. Erosion control barriers shall be installed along the proposed work area. This erosion control barrier shall also serve as a limit of work. It is recommended that only siltation fence and/or silt sock be used for erosion control in order to minimize the potential for invasion by weed species.
- Rough grades shall be verified by field survey to confirm design elevations have been met. Adjustments shall be made as directed by the wetland scientist.
- 4. The stormwater basin shall be planted in accordance with the planting schedule provided.
- 5. Plantings will be with container grown nursery stock. Substitutions may be required depending on availability and cost. It is recommended that the stormwater wetland basin plantings be conducted under the supervision of a wetland scientist experienced in the construction of wetlands.
- 6. Symbol on the planting plans represent a cluster of thirty (30) plants.

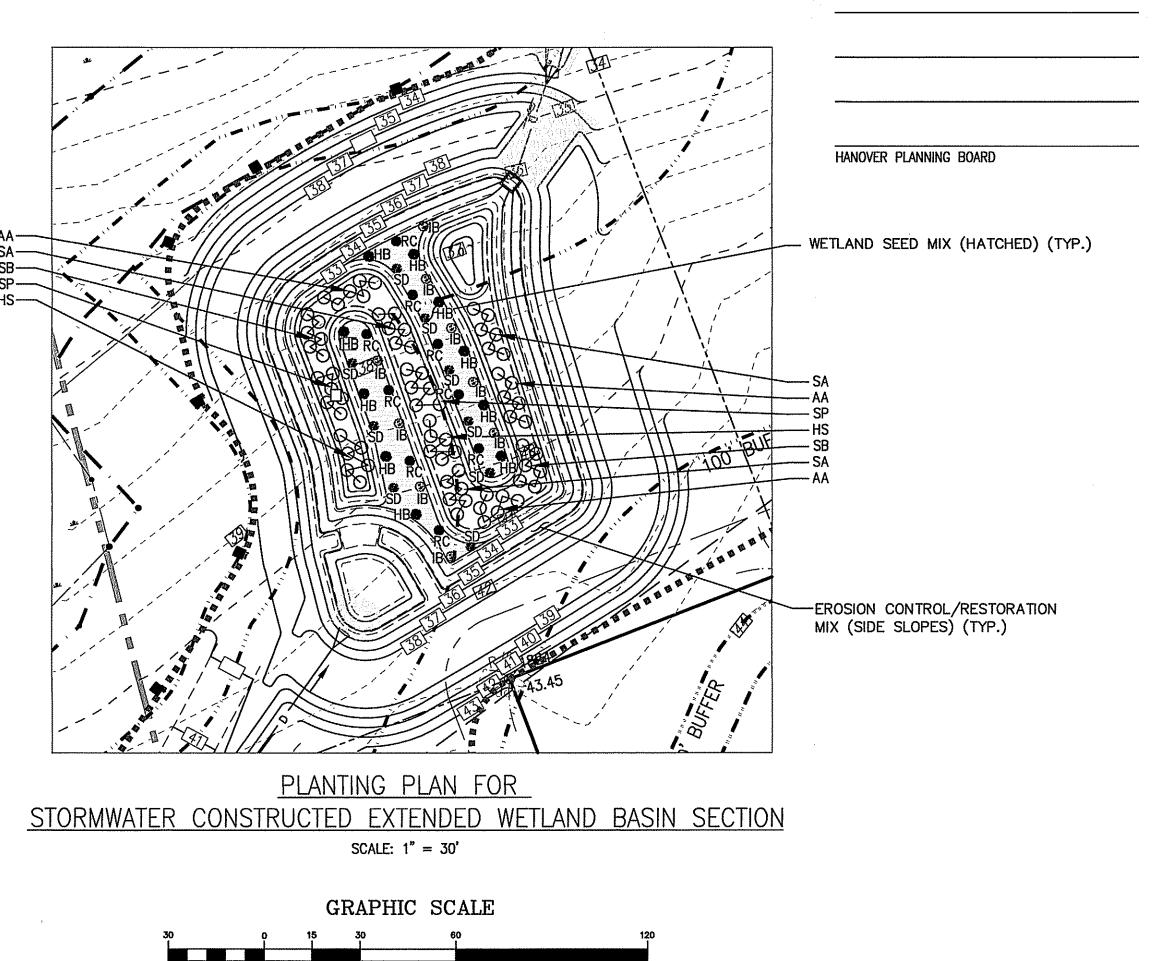

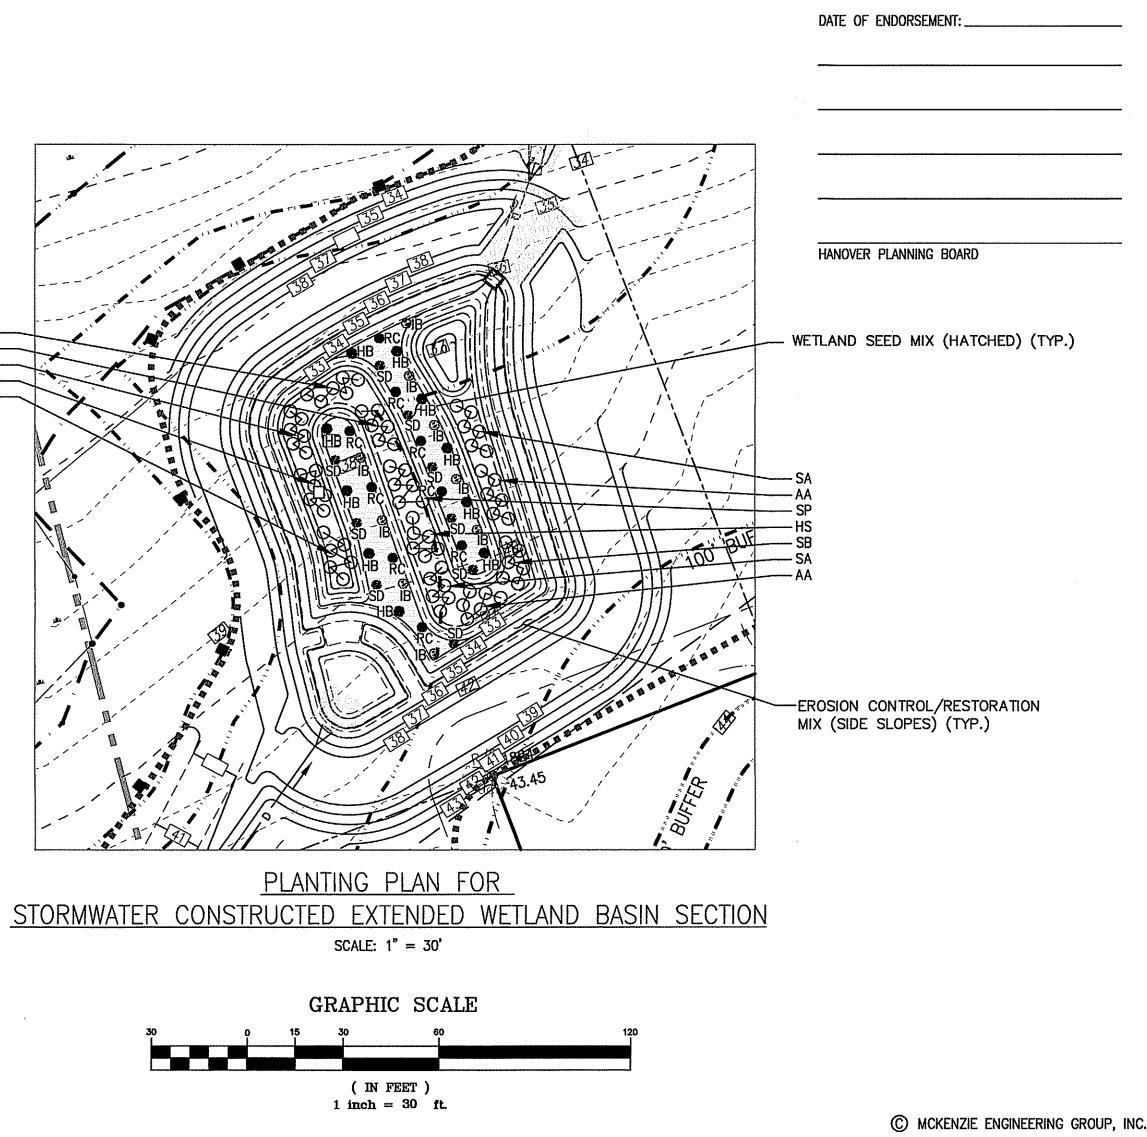

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M C K E N Z I E ENGINEERING GROUP

Assinippi Office Park 150 Longwater Drive, Suite 101

REGISTERED PROFESSIONAL ENGINEER:

DRAWN BY:

DESIGNED BY: CHECKED BY: APPROVED BY:

PROJECT NO .:

DWG. TITLE:

DWG. No:

DECEMBER 14, 2020

Landscaping

Plan

AS SHOWN

217-106

Norwell, MA 02061

P: 781.792.3900 F: 781.792.0333

www.mckeng.com

CLERK OF THE TOWN

, SUBJECT TO COVENANT

APPROVAL UNDER THE SUBDIVISION CONTROL


LAW REQUIRED

DATE OF APPLICATION:

DATE OF HEARING:

DATE OF APPROVAL:

AND RECORDED AT

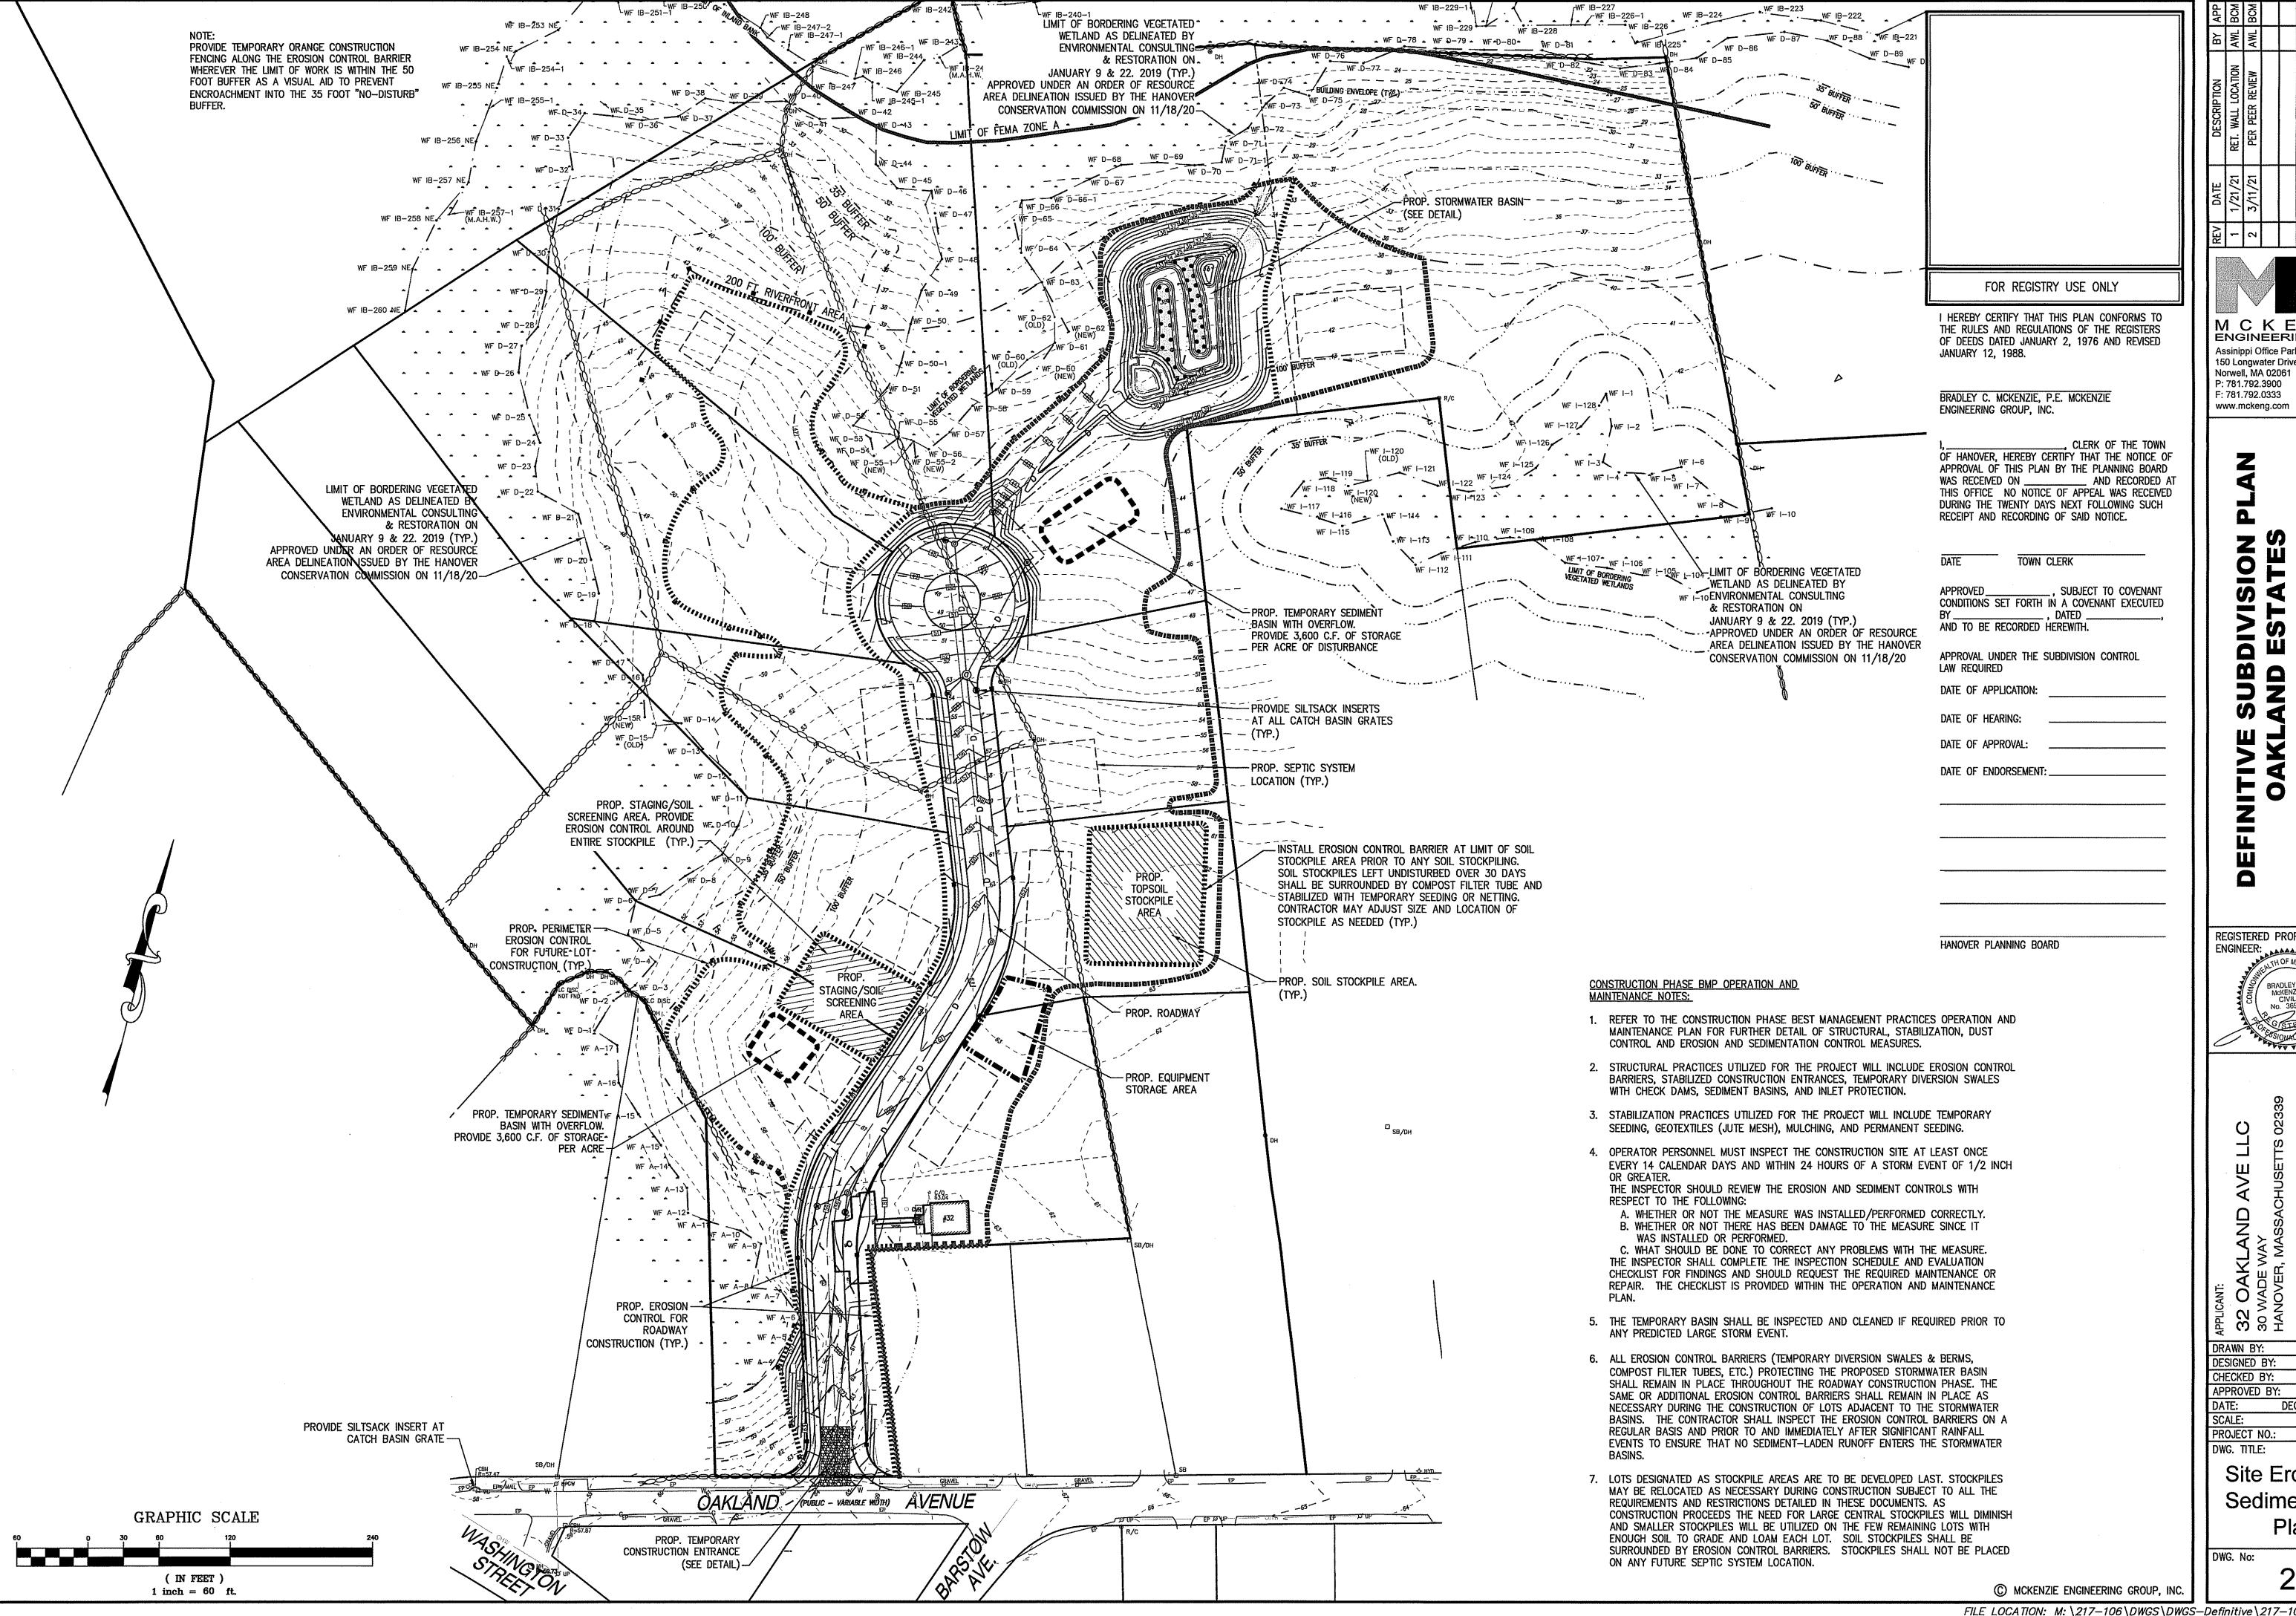

REGISTERED PROFESSIONAL
ENGINEER:
EALTH OF MASO
BRADLEY C MCKENZIE CIVIL
BRADLEY C MCKENZIE
4 No. 36917
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Site Erosion & Sedimentation